

## **CLERMONT COUNTY PARK DISTRICT KSM PARK STRUCTURE KATHRYN STAGGE-MARR PARK SHELTER STRUCTURE**

# **ISSUED FOR CONSTRUCTION**

### **GENERAL NOTES**

- A. FIELD VERIFY INFORMATION, DIMENSIONS, ETC. PRIOR TO ORDERING OR FABRICATING MATERIALS OR BEGINNING CONSTRUCTION.
- THE CONTRACTOR SHALL ARRANGE FOR THE PREMISES TO BI MAINTAINED IN AN ORDERLY MANNER. FREE OF DUST AND DEBRI THROUGHOUT THE COURSE OF THE WORK. PROVIDE AND MAINTAIN TEMPORARY BARRICADES AS REQUIRED TO PROTE THE PUBLIC AND OWNERS PERSONNEL DURING CONSTRUCTION THE CONTRACTOR SHALL BE RESPONSIBLE FOR ANY DAMAGE TO THE EXISTING STRUCTURE OR EQUIPMENT. ANY SUCH DAMAGE SHAL BE REPAIRED AT THE CONTRACTOR'S EXPENS
- CONTRACTOR SHALL PROVIDE DAILY OR MORE FREQUEN GENERAL CLEAN UP IN COMPLIANCE WITH OWNER'S REQUIREMENTS OF AREAS WITHIN THE LIMITS OF CONSTRUCTION AND FINAL CLEAN UP AT CONCLUSION OF WORK
- CONTRACTOR TO REVIEW OTHER DRAWINGS ISSUED FOR THIS PROJECT FOR ADDITIONAL INFORMATION FROM OTHER TRADES TO COORDINATE THE REQUIRED SCOPE OF WORK.
- DO NOT SCALE FROM THE DRAWINGS. WRITTEN DIMENSIONS SHALL TAKE PRECEDENCE. THE OWNER'S REPRESENTATIVE MUST BE NOTIFIED OF ANY CONFLICTS IN DIMENSIONING.
- ALL DIMENSIONS ARE TO FACE OF CMU, MASONRY OPENINGS, STUE WALLS, OR COLUMN CENTERLINE UNLESS OTHERWISE NOTED
- G. ALL MATERIALS, FIXTURES AND EQUIPMENT INDICATED IN THE CONSTRUCTION DOCUMENTS SHALL BE NEW AND AS SPECIFIED. UNLESS IDENTIFIED OTHERWISE.
- H. ALL NEW FINISHED AND PATCHED SURFACES SHALL BE SMOOTH CONTINUOUSLY FREE OF IMPERFECTIONS AND IN PROPER CONDITION TO RECEIVE THE SPECIFIED FINISH. PATCHED AREAS SHALL MATCH THE ADJACENT MATERIALS CONSTRUCTION AND FINISH.
- I. ALL FLOORS ON EITHER SIDE OF A DOORWAY OR OPENING SHALL BE LEVEL AND HAVE A MAXIMUM ELEVATION DIFFERENCE OR THRESHOLD HEIGHT OF 1/2".
- J. DOOR OPENINGS NOT LOCATED BY DIMENSION SHALL BE 4" FROM THE FACE OF FINISHED WALL TO OUTSIDE EDGE OF DOOR FRAME JAMB UNLESS NOTED OTHERWISE.
- K. ARCHITECTURAL DATUM 0'-0" = FINISHED FLOOR.
- L. DOOR SIZES, STYLES, AND SPECIFICATIONS, ROUGH OPENING SIZES AND EXACT LOCATIONS TO BE CHECKED AND VERIFIED BY THE CONTRACTOR BEFORE ORDERING AND BEFORE CONSTRUCTION BEGINS.
- M. PROVIDE FIRE EXTINGUISHER COMPLYING WITH NFPA 10, AS INDICATED ON LIFE SAFETY DRAWINGS WITH MAX TRAVEL DISTANCE OF 75'.
- N. ALL EXPOSED WOODS TO BE STAINED TO MATCH. ENTIRE BUILT WOOD STRUCTURE INCLUDING COLUMN POSTS, ARCHES, PURLINS, BEAMS, CONNECTOR PLATES, SHEATHING, WOOD DECKING CEILING, BENT BEADED PLYWOOD CEILING, TOP PLATES, EDGE TRIMS, 2X TRUSS FRAMING, CUPOLA STRUCTURE, AND ALL OTHER WOOD ELEMENTS TO BE PART OF A PRE-ENGINEERED SYSTEM. PRE-ENGINEERED SYSTEM TO BE FIELD VERIFIED & INSTALLED IN CONJUNCTION WITH SYSTEM MFR. AND CONTRACTOR. FIELD VERIFY SIZES OF ALL ELEMENTS WILL FIT CORRECTLY TOGETHER SUCH THAT ALL FASCIAS, ROOFS, ETC. ALIGN PRIOR TO ORDERING AND INSTALLATION. CONNECTOR PLATES TO BE UTILIZED AS PER MFR. RECOMMENDATIONS. ALL EXPOSED CONNECTOR PLATES TO BE DECORATIVE OVERSIZED GUSSET PLATES & BOLTS FINISHED POWDER BLACK.
- O. MATERIALS SHOWN IN DRAWINGS ARE BASIS OF DESIGN. ARCHITECT AND OWNER APPROVED EQUALS OF ALL MATERIALS MAY BE APPROVED AND ACCEPTED. OWNER TO APPROVE OF ALL WARRANTY SYSTEMS PRIOR TO ORDERING.

G-001

S-101

S-102

S-103

S-104

A-101

A-111

A-121 A-131

A-201

A-601

E-101


### SHEET INDEX


SHEET NUMBER	SHEET NAME
G-001	COVER SHEET
S-101	FOUNDATION PLAN
S-102	SLAB PLAN
S-103	MASONRY PLAN
S-104	DETAILS
A-001	SYMBOLS AND ABBREVIATIONS
A-101	FLOOR PLAN
A-111	REFLECTED CEILING PLAN
A-121	ROOF PLAN
A-131	ROOF FRAMING PLAN
A-201	BUILDING ELEVATIONS
A-601	DOOR SCHEDULE & TYPES
E-101	LIGHTING AND POWER PLAN


### **PROJECT INFORMATION**

PROJECT NAME:	10018207 - CLERMONT CO KATHRYN STAGGE-MARR PARK SHELTER
PROJECT LOCATION:	KATHRYN STAGGE-MARR PARK 6662 GOSHEN RD. GOSHEN, OH 45122
OCCUPANCY CLASSIFICATION:	U (UTILITY)
GOVERNING BUILDING CODE:	2017 OHIO BUILDING CODES (2012 INTERNATIONAL BUILDING CODE)
PROJECT TYPE:	NEW BUILDING, CONSTRUCTION TYPE II B
SPRINKLERS:	NONE
NUMBER OF STORIES:	1 STORY
PROJECT AREA:	1,788 SQ/FT OPEN SHELTER <u>318</u> SQ/FT ENCLOSED STORAGE 2,106 SQ/FT TOTAL


E	ACHITECTURE JENGINEERING J GEOSPATIAL At54 IDEA CENTER BOULEVARD DAYTON, OH 45430-1500 37.461.5660
	ISSUED FOR CONSTRUCTION
D	ISSUANCE SCHEDULE DESCRIPTION
	BER DATE
С	CLERMONT PARKACCT Follow the Park District
В	CLERMONT COUNTY PARK D KSM PARK SHELTE KATHRYN STAGGE-MARR PA KATHRYN STAGGE-MARR PA KATHRYN STAGGE-MARR PA 662 GOSHEN STRUCTURE 662 GOSHEN RJ 662 GOSHEN RJ 662 GOSHEN RJ
A	PROJECT NO: 10018702 DATE ISSUED: 08/02/2023 DESIGNED BY: J. DOBROZSI DRAWN BY: G. RODDY CHECKED BY: J. DOBROZSI <u>SHEET NAME:</u> COVER SHEET
	<u>SHEET NO:</u> <b>G-001</b>

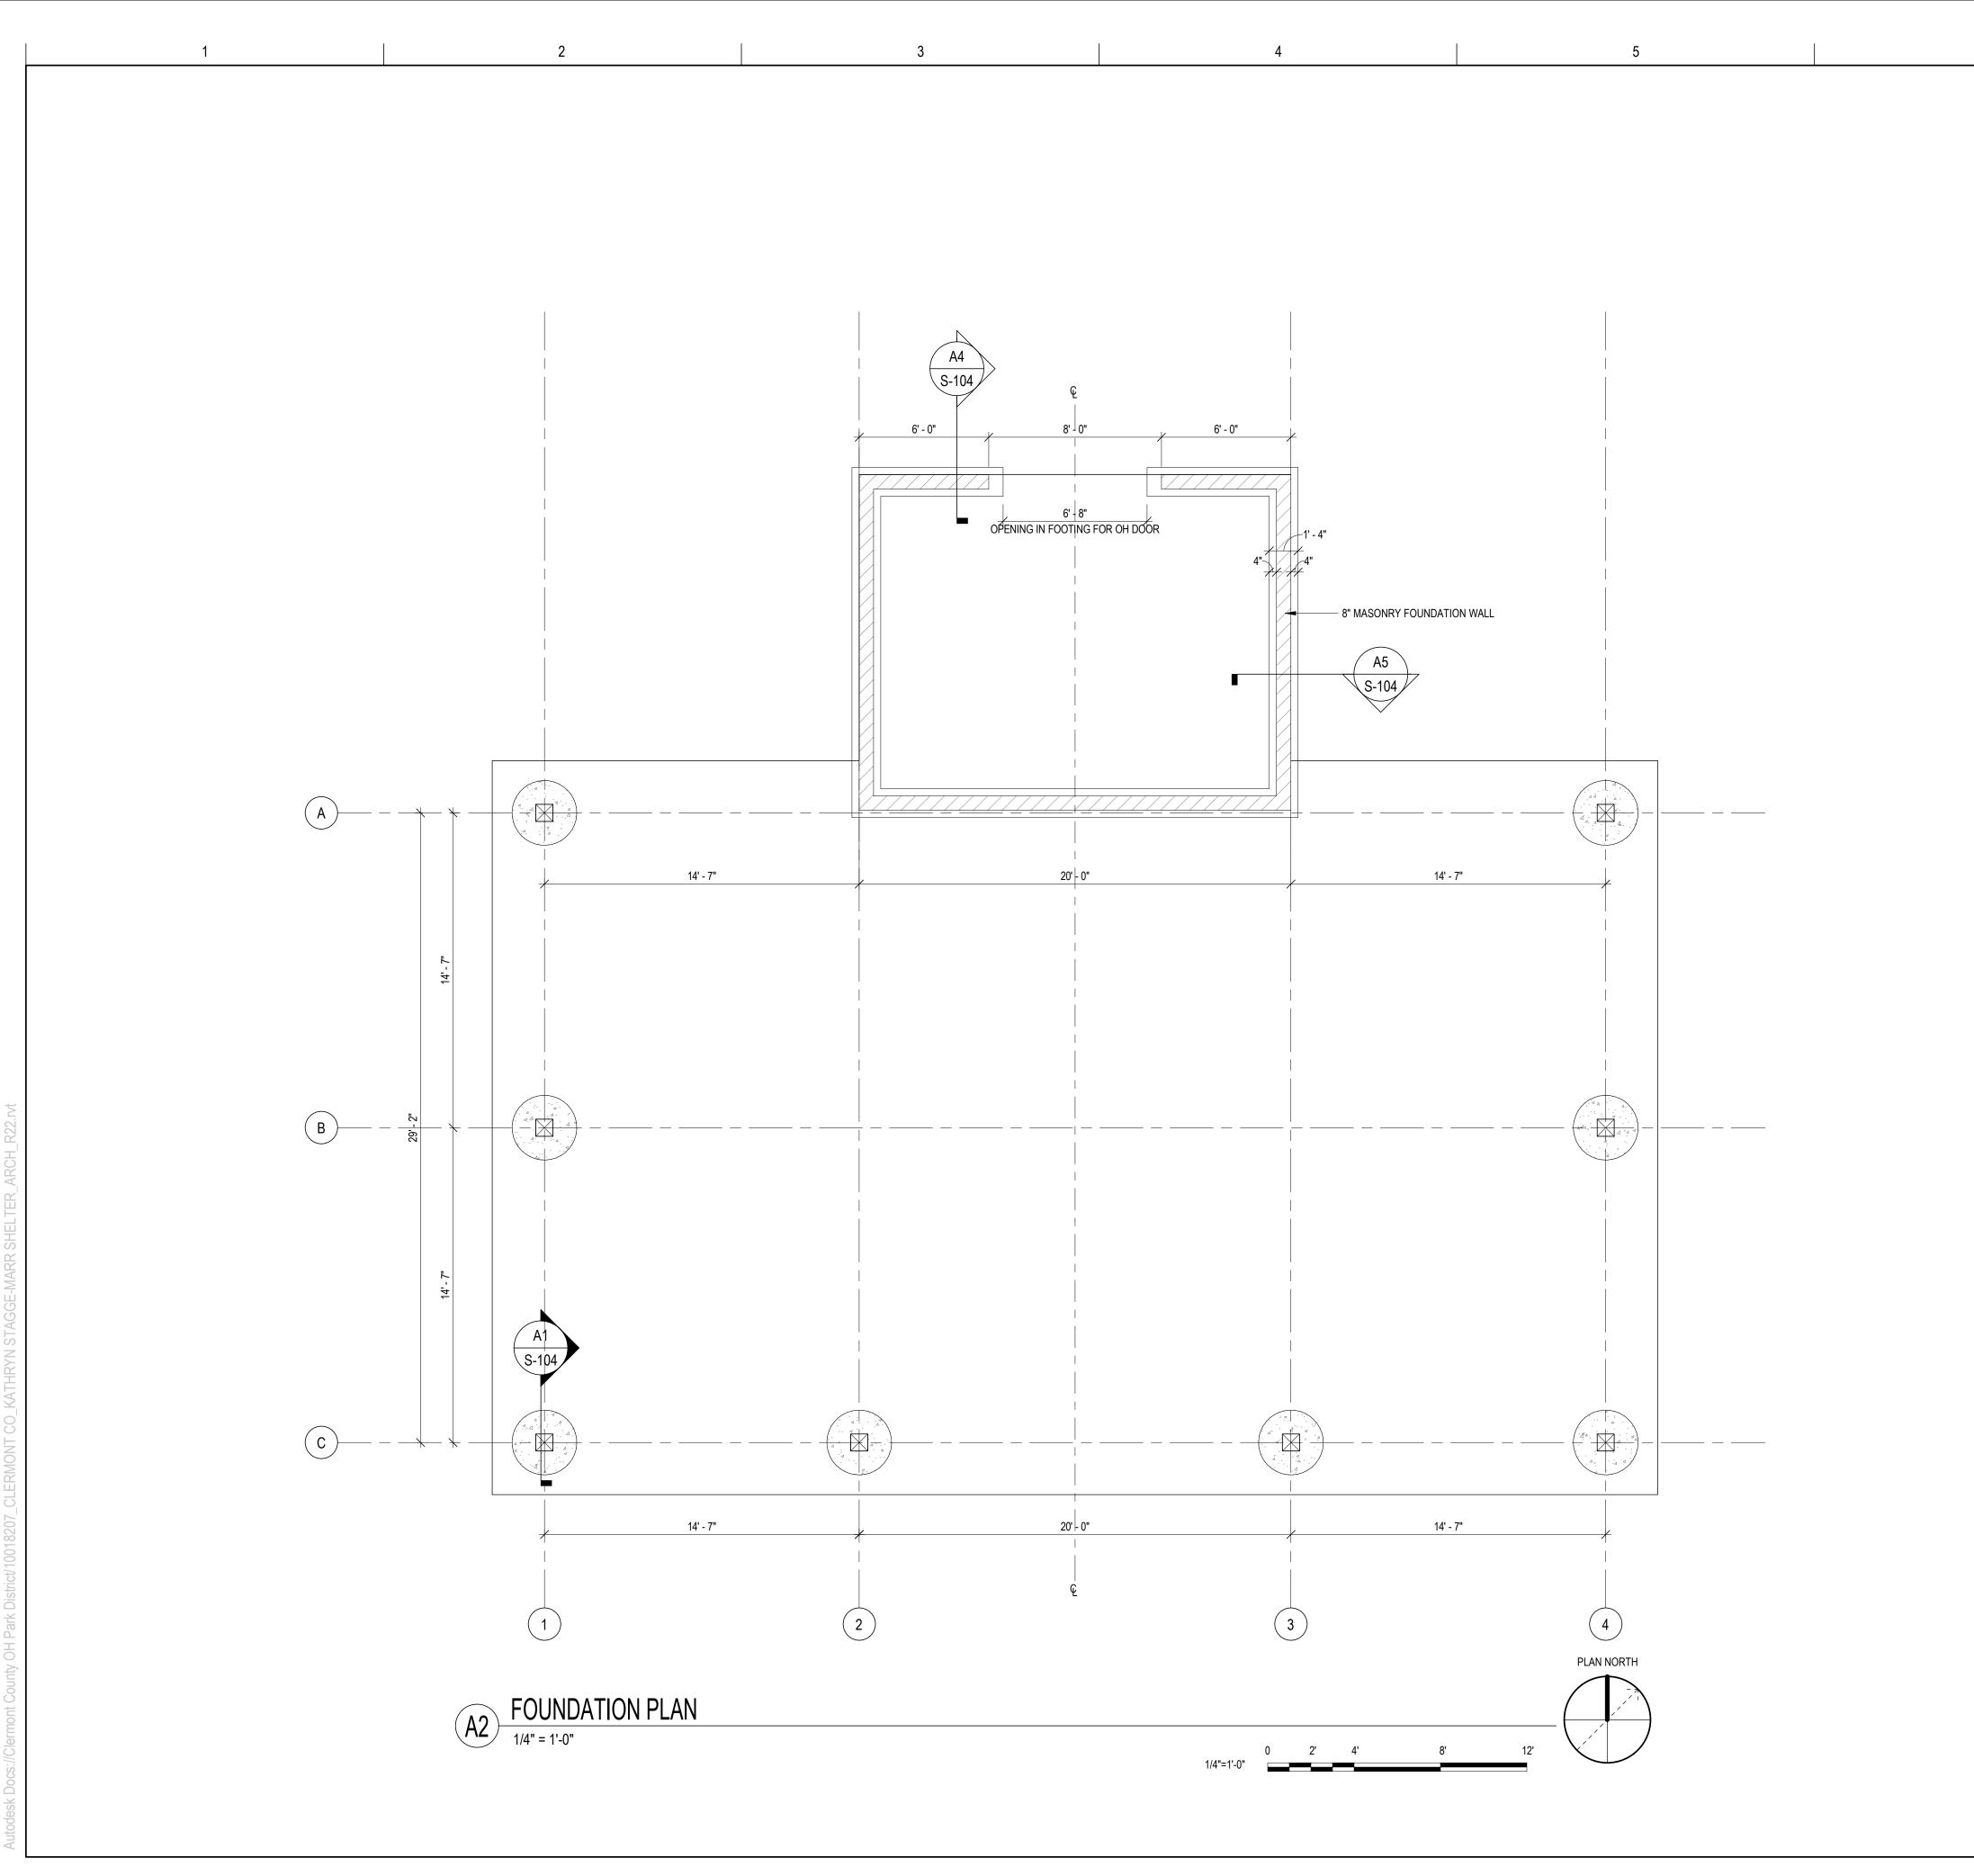


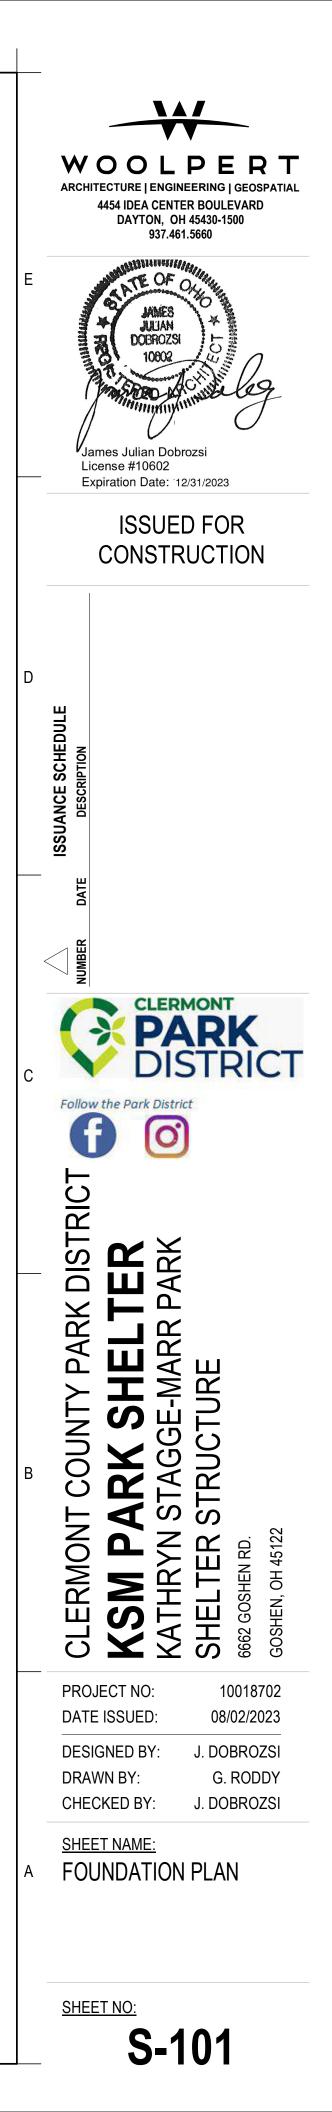


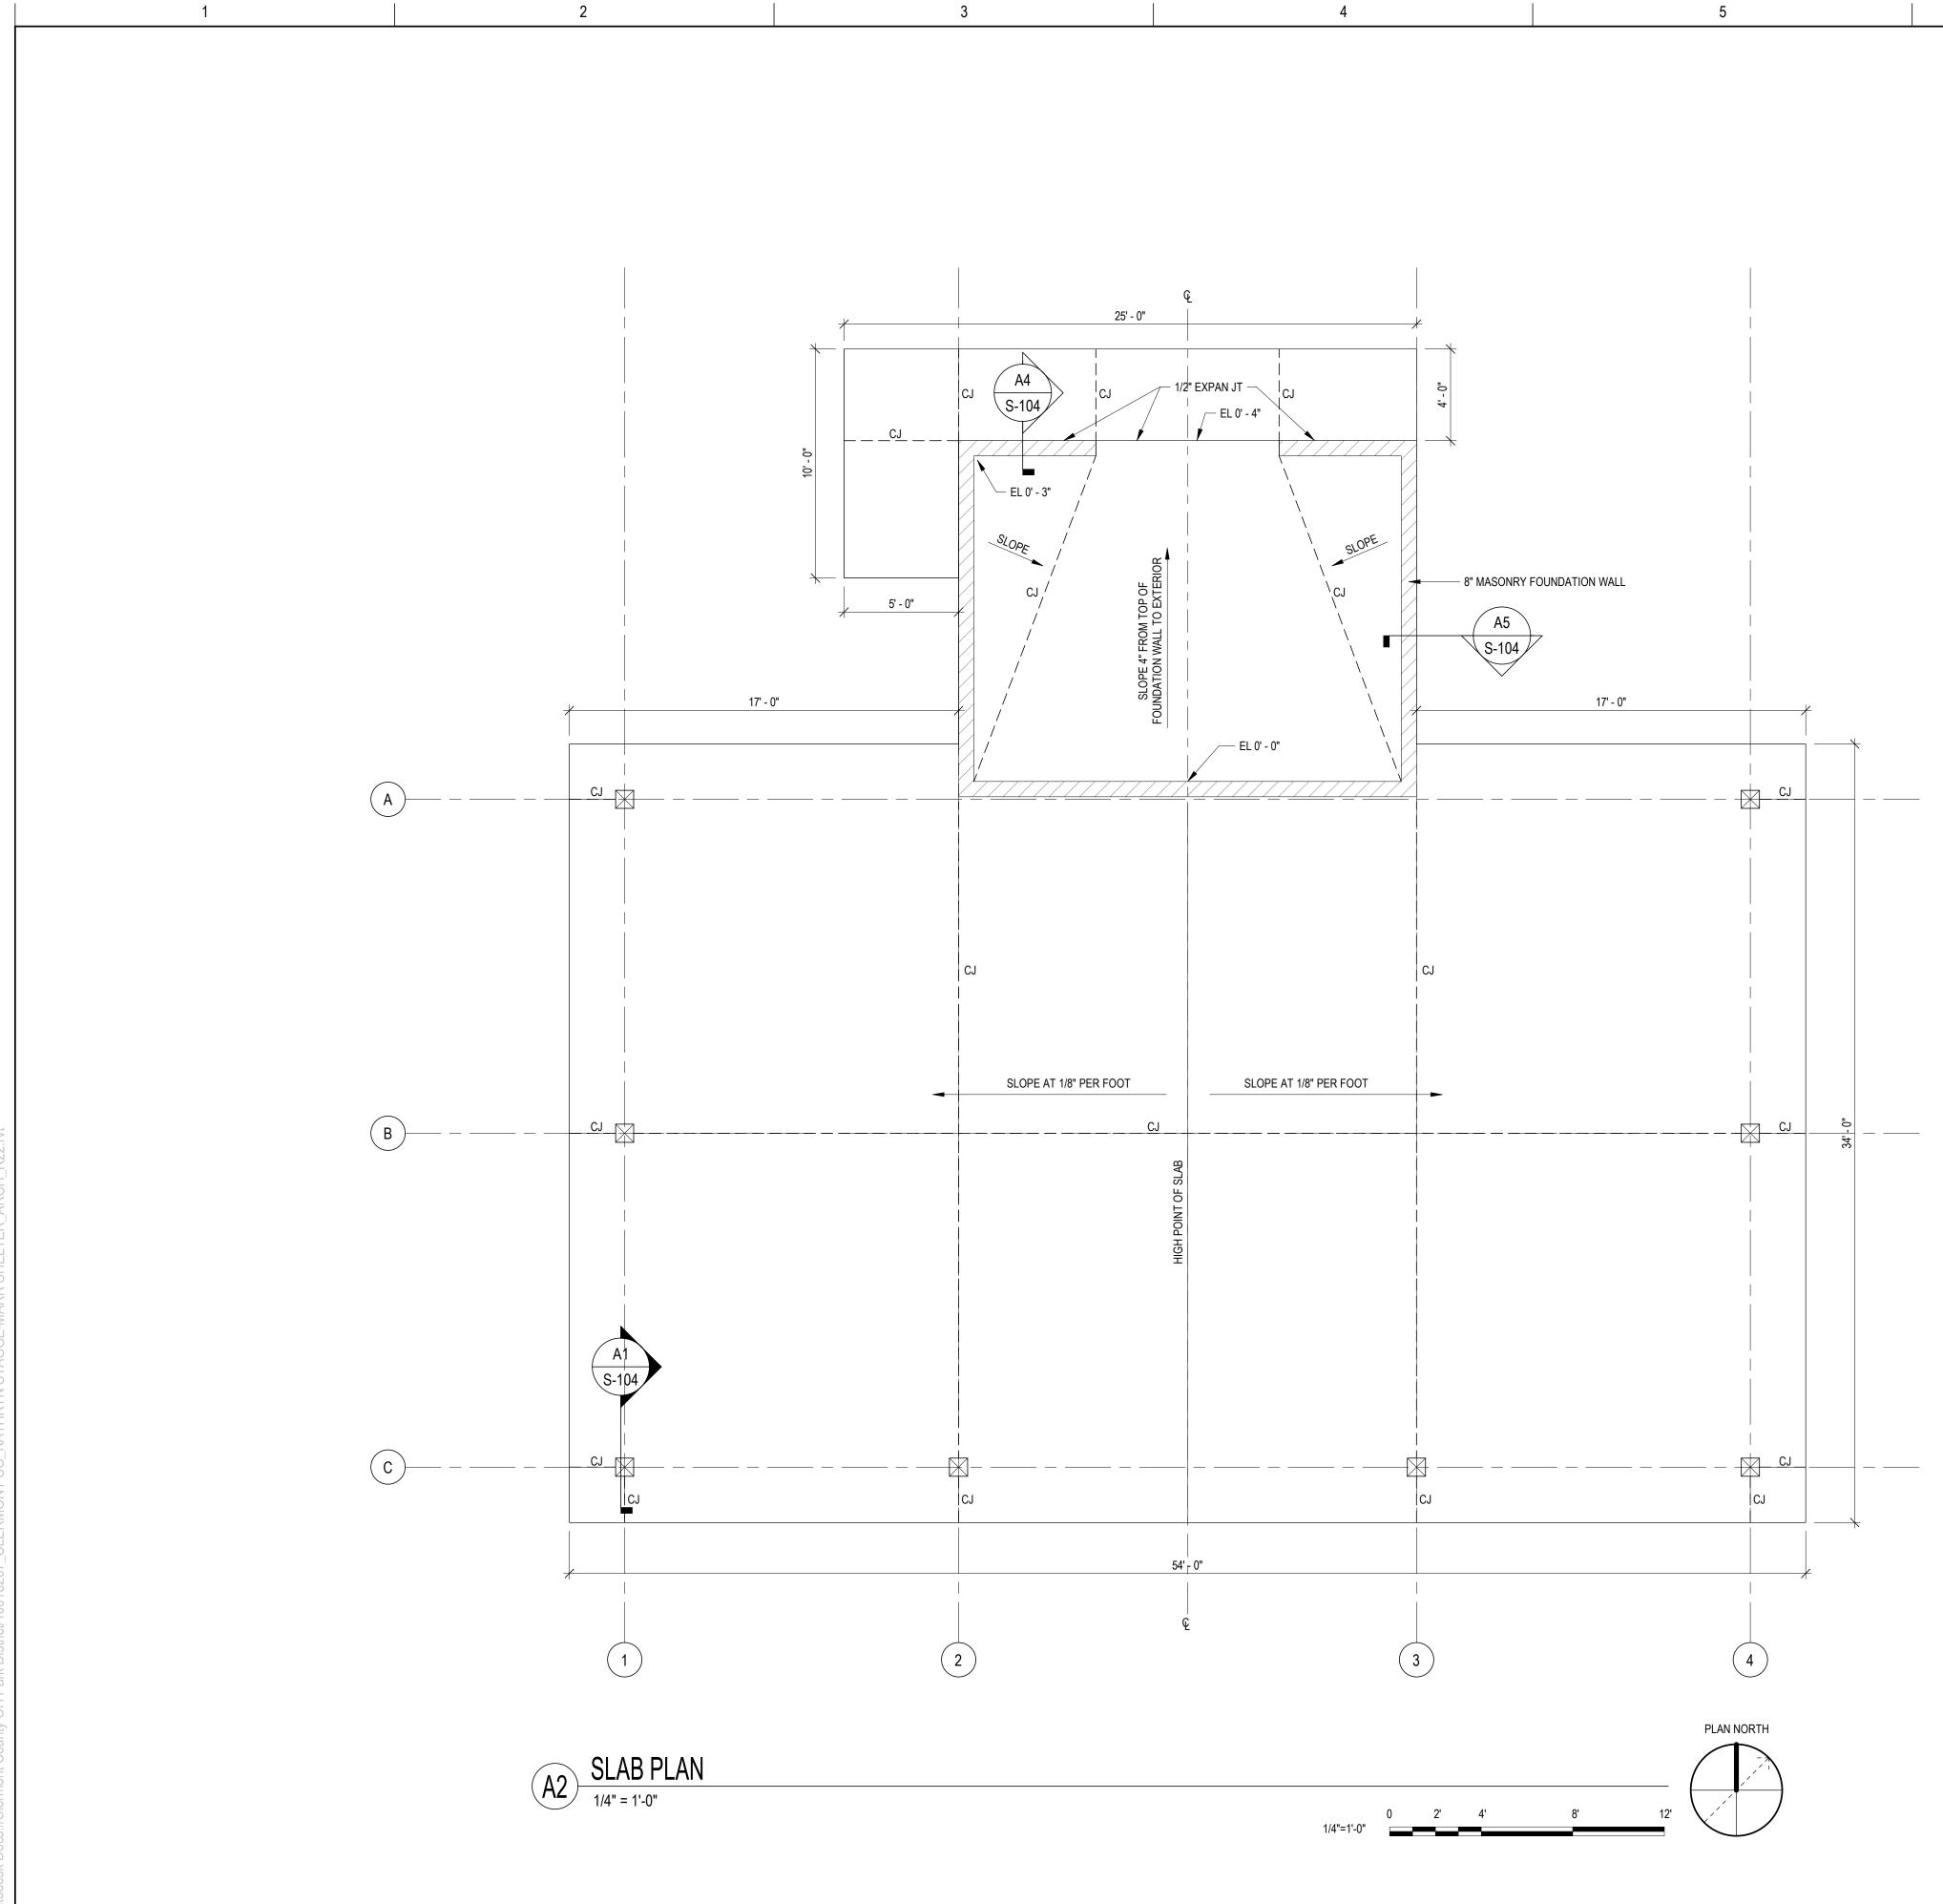




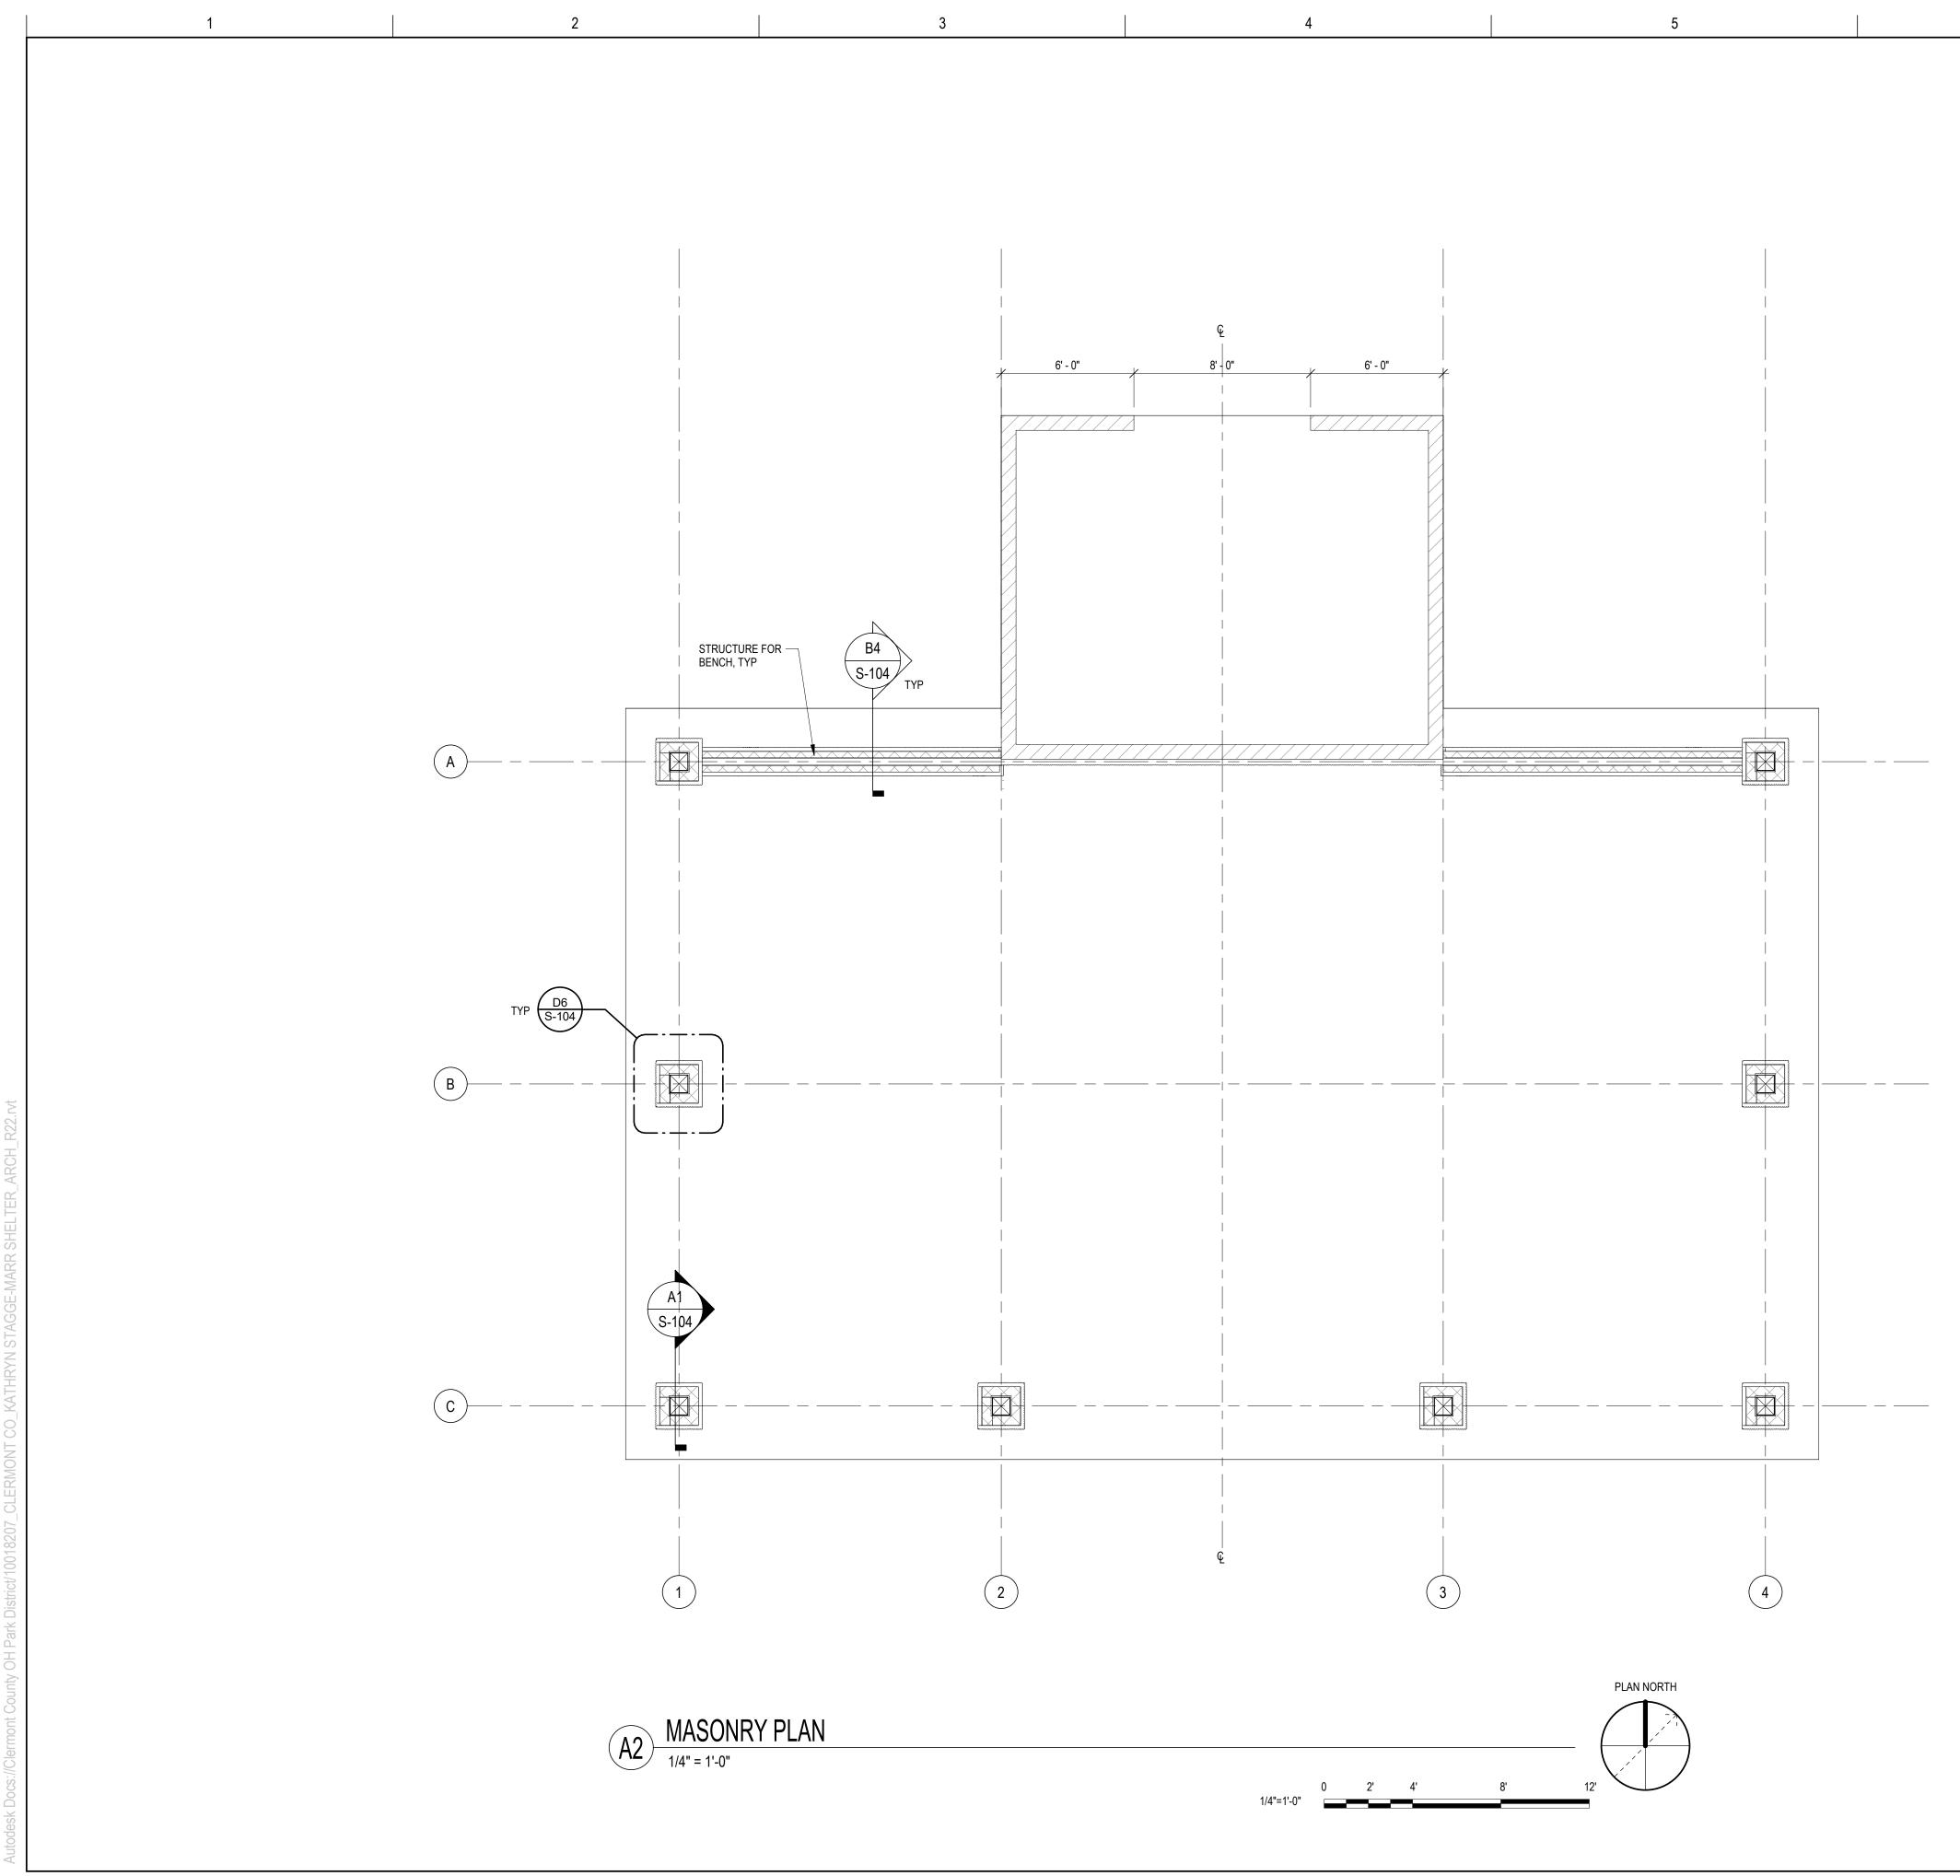

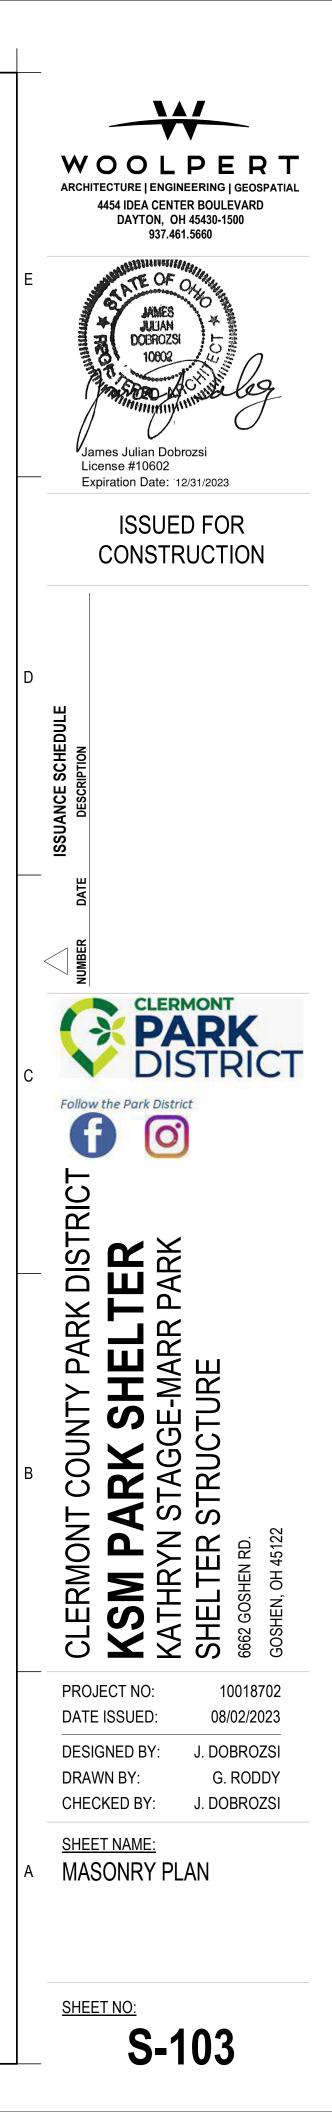

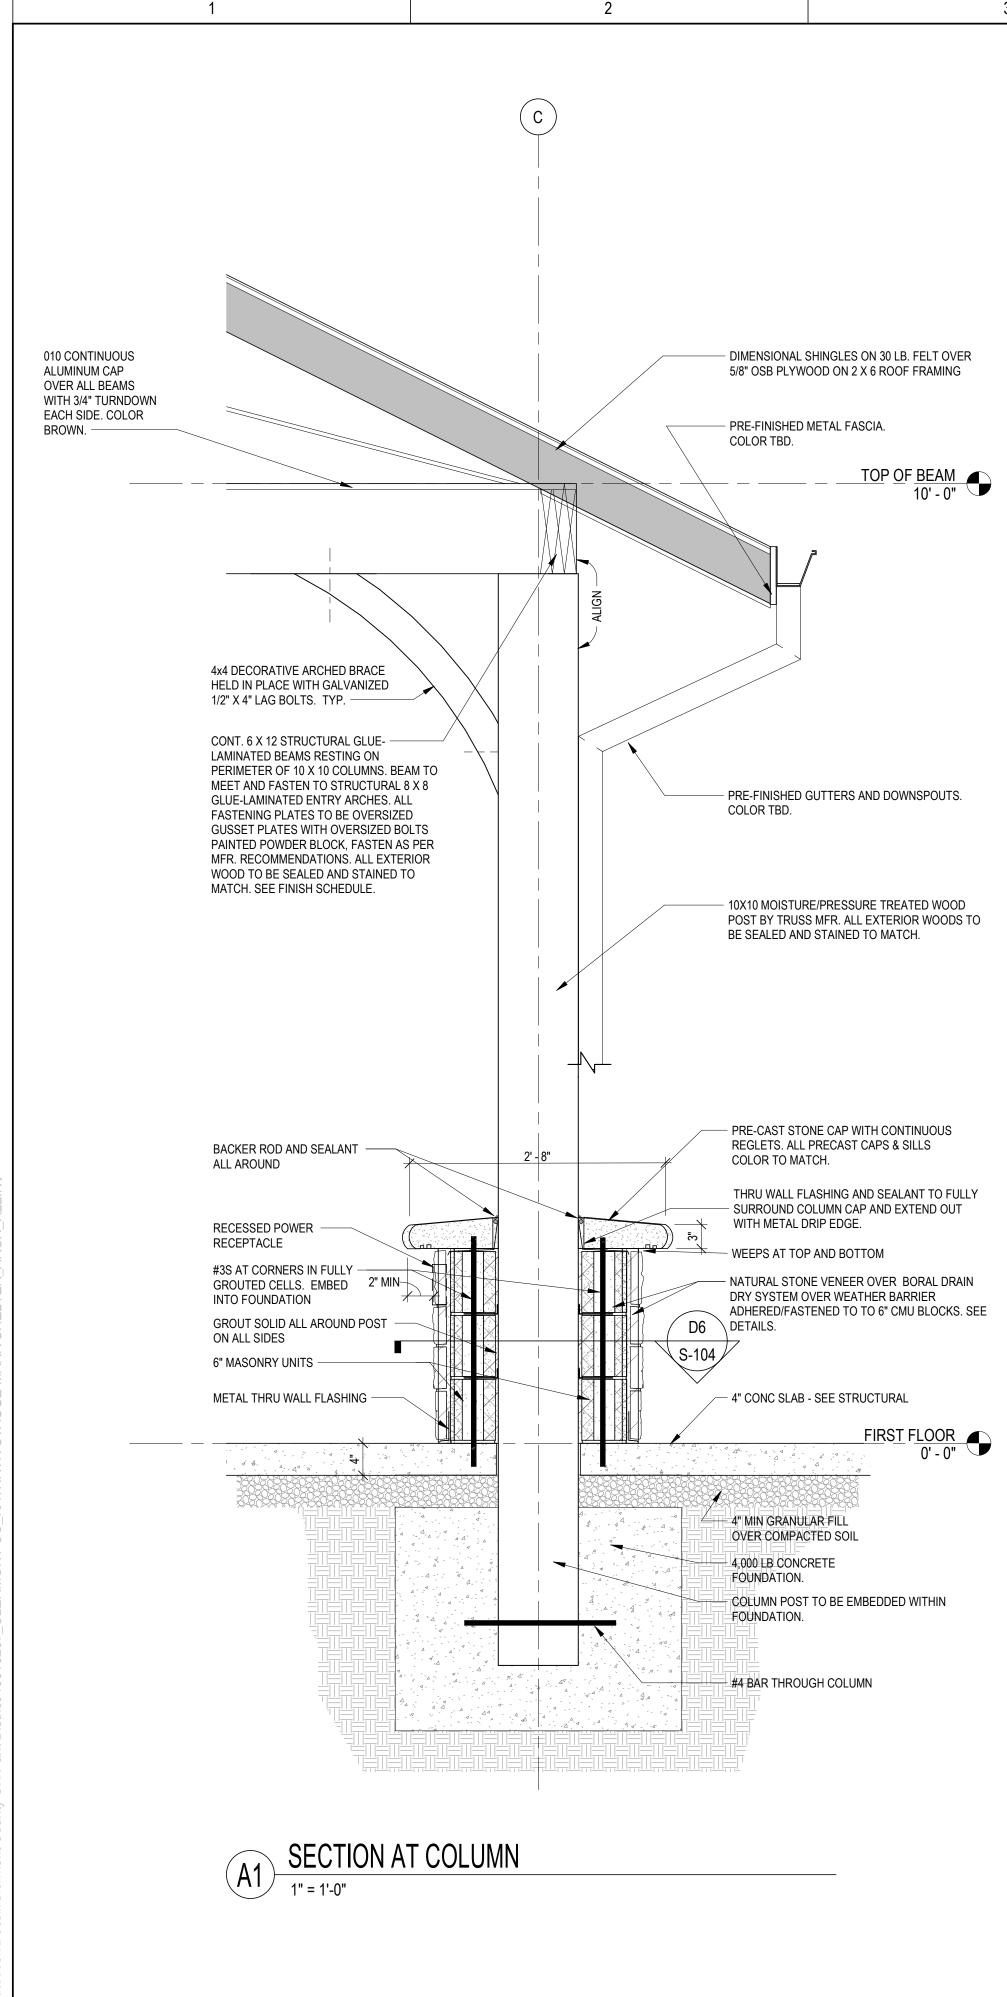


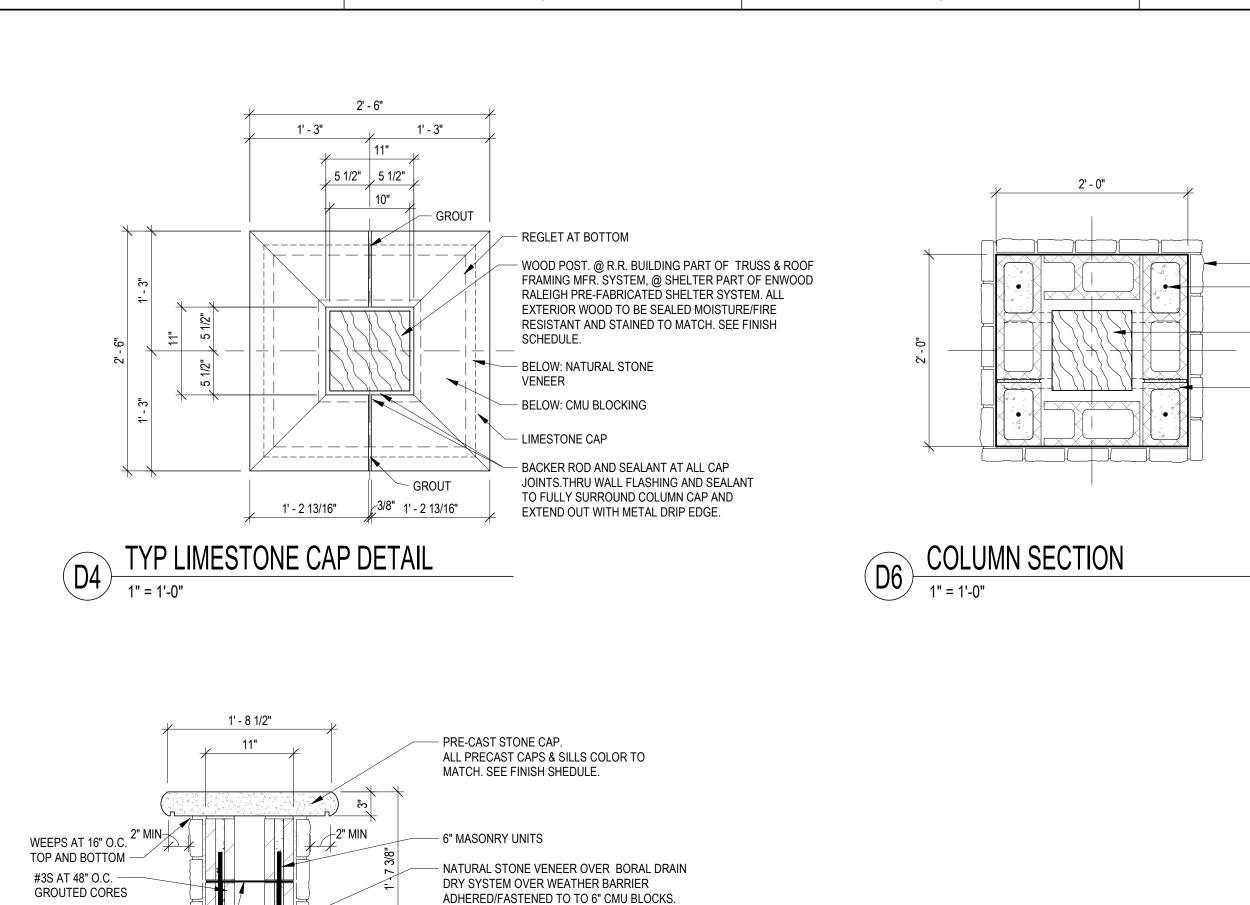


4" CONC SLAB - SEE STRUCTURAL

- THRU-WALL METAL FLASHING

- 4" MIN GRANULAR FILL OVER COMPACTED SOIL

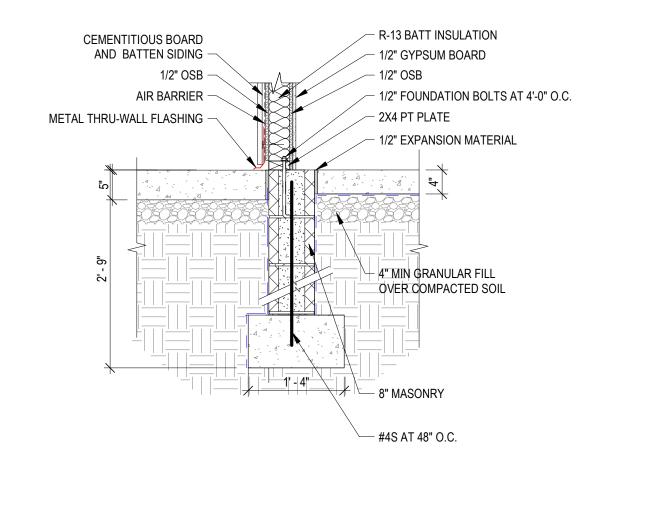

B4 STONE SEAT SECTION 1" = 1'-0"

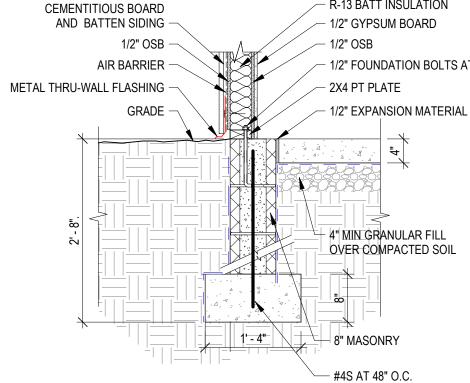



4

9 GA WIRE TRUSS




- APPLIED STONE FACE - #4 CONTINUOUS AT EACH CORNER IN GROUTED CELL - 10X10 PRESSURE

TREATED COLUMN

- CORRUGATED STRAP TIE AT TOP OF EACH ROW OF MASONRY AT EACH CORNER

- R-13 BATT INSULATION

- 1/2" FOUNDATION BOLTS AT 4'-0" O.C.

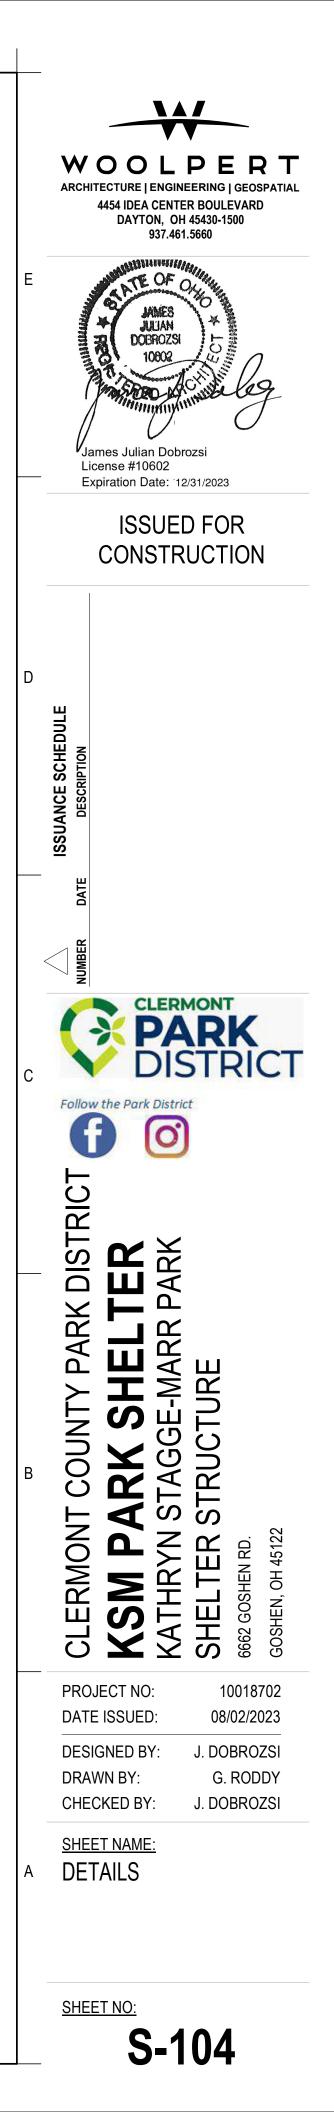


ABBREVIA	TIONS				
	SYMBOLS		F Cont'd.		Р
0		FEC	FIRE EXTINGUISHER CABINET	PC	
& ∠	AND ANGLE	FH	FLAT HEAD	PC PL	PRECAST CONC PLATE
@	AT	FIN	FINISH	PEMB	PRE-ENGINEERI
Ŭ L	CENTER LINE	FLR	FLOOR	PLAS	PLASTER
Ø	DIAMETER	FLUOR	FLUORESCENT	PLYWD	PLYWOOD
Ľ	CHANNEL	F.PRG FR	FIREPROOFING FRAME	PORC	PORCELAIN
	A	FRT	FRAME FIRE RETARDANT TREATED	PSF	POUNDS PER SO
		FSEP	FOOD SERVICE EQUIPMENT PROVIDER	PSI	POUNDS PER SO
ACOUS ACP	ACOUSTICAL ACOUSTICAL PANEL	FT	FOOT	PT	
ACPL	ACOUSTICAL PLANEL	FTG	FOOTING	PTD PTN	PAPER TOWEL I PARTITION
ACT	ACOUSTICAL CEILING TILE	FV	FIELD VERIFY	PVC	POLYVINYL CHL
ADJ	ADJUSTABLE		G	1.40	Q
AFF	ABOVE FINISHED FLOOR	G	GROUND		
AFG	ABOVE FINISHED GRADE	G BLK	GLAZED BLOCK	QT	QUARRY TILE
AHR	ANCHOR	GA	GAUGE		R
ALT	ALTERNATE	GALV	GALVANIZED	R	RADIUS
ALUM		GB	GYPSUM BOARD	R	RISERS
APPROX AP	APPROXIMATELY ACOUSTICAL PANEL	GC	GENERAL CONTRACTOR	RB	RESILIENT BASE
AP	ACCENT PAINT	GEN	GENERAL	RBR	RUBBER
ATTEN	ATTENUATION	GFCI	GROUND FAULT CIRCUIT INTERRUPT	RCP	REFLECTED CE
	В	GI	GALVANIZED IRON	RD	ROOF DRAIN
BD	BOARD	GL CL PLK	GLASS	REC	RECESSED
BLDG	BUILDING	GL BLK GS	GLASS BLOCK GROUT SOLID	REF	REFERENCE
BLK	BLOCK	GT	GLAZED TILE	REINF REQD	REINFORCED REQUIRED
BM	BEAM	GT	GROUT	RES	RESISTANT
BMD	BOTTOM OF METAL DECK	GWB	GYPSUM WALL BOARD	RES	RESILIENT
BOD	BOTTOM OF DECK	GYP	GYPSUM	RESIL	RETAINING
BOT	BOTTOM	GYP BD	GYPSUM BOARD	RM	ROOM
BRG	BEARING	GYP PLAS	GYPSUM PLASTER	RO	ROUGH OPENIN
BRK	BRICK		Н		S
BSMT	BASEMENT				
	С	HC	HOLLOW CORE	S	SOUTH
CAB	CABINET	HD HDW	HEAD HARDWARE	SC	SEALED CONCR
CB	CATCH BASIN	HDWD	HARDWOOD	SCHED SCW	SCHEDULE SOLID CORE WO
CEM	CEMENT	HM	HOLLOW METAL	SECT	SECTION
CEM PLAS	CEMENT PLASTER	HNDRL	HANDRAIL	SHT	SHEET
CER	CERAMIC	HORIZ	HORIZONTAL	SIM	SIMILAR
CG	CORNER GUARD	HT	HEIGHT	SKF	SPECIALTY KIT
CJ	CONTROL JOINT		I	SLNT	SEALANT
CLG	CEILING	ID	INSIDE DIAMETER	SPEC	SPECIFICATION
CM CMU	CERAMIC MOSAIC CONCRETE MASONRY UNIT	IN	INCH	SQ	SQUARE
CMU	CLEAN OUT	INSUL	INSULATION	SRB	STAIR RUBBER
COL	COLUMN	INT	INTERIOR	SSMR SST	STANDING SEAI STAINLESS STE
CONC	CONCRETE	INV	INVERT	STD	STANDARD
CONSTR	CONSTRUCTION		J	STL	STEEL
CONT	CONTINUOUS	JAN	JANITOR	STUC	STUCCO
CPT	CARPET	JT	JOINT	STRUCT	STRUCTURAL
CR	COLD ROLLED	J-BOX	JUNCTION BOX	SUSP	SUSPENDED
CT	CERAMIC TILE		K	SV	SHEET VINYL
CTB	CERAMIC TILE BASE				Т
CTW	CERAMIC TILE WAINSCOT	KIT	KITCHEN	Т	TREADS
	D	KPL	KICKPLATE	, Т&В	TOP AND BOTTO
DBL	DOUBLE		L	T&G	TONGUE AND G
DET	DETAIL	LAM	LAMINATE	ТВ	TACK BOARD
DIA	DIAMETER	LAV	LAVATORY	TEL	TELEPHONE
DIAG	DIAGONAL	LINO	LINOLEUM	TER	TERRAZZO
DIM	DIMENSION	LT WT	LIGHT WEIGHT	TFF	TO FINISHED FA
DISP	DISPENSER	LVR	LOUVER	TOC	TOP OF CONCR
DN	DOWN		Μ	TOM TOS	TOP OF MASON TOP OF STEEL
DR	DOOR	MACH	MACHINE	TOS	TOP OF STEEL
DS	DOWNSPOUT	MACIT	MAXIMUM	THRU	THROUGH
DWG	DRAWING	MB	MARKER BOARD	TS	TACK STRIP
	E	MB/MR	MARKER BOARD/MAP RAIL	TTD	TOILET TISSUE
E	EAST	MECH	MECHANICAL	TYP	TYPICAL
EA	EACH	MFR	MANUFACTURER		U
EG	EDGE GUARD	MGB	MOISTURE GYPSUM BOARD		0
EH	ELECTRIC HEATER	MGYP BD	MOISTURE GYPSUM BOARD	UR	URINAL
EIFS	EXTERIOR INSULATION FINISH SYSTEM	MH		UNO	UNLESS NOTED
EJ	EXPANSION JOINT	MIN MIRR	MINIMUM MIRROR		V
EL	ELEVATION				
ELEC	ELECTRICAL	MR MO	MOISTURE RESISTANT MASONRY OPENING	VCP	VITRIFIED CLAY
ELEV	ELEVATION	MU	MASONRY OPENING MASONRY UNITS	VCT	VINYL COMPOS
ENAM	ENAMEL	MTL	MASONRY UNITS	VET	
EPT	EPOXY PAINT	MULL	MULLION	VERT	VERTICAL
EQ	EQUAL		N	VWB VWC	VENTED WALL E
EQUIP		N	NORTH	v v v O	
EW		NIC	NOT IN CONTRACT		W
EWC	ELECTRIC WATER COOLER	NOM	NOMINAL	W	WEST
EXIST	EXISTING	NTS	NOT TO SCALE	W/	WITH
EXP	EXPANSION		0	WC	WATER CLOSET
EXP	EXPOSED STRUCTURE	OC	ON CENTER	WD	WOOD
EXT	EXTERIOR	OH	OVERHANG	WF	WIDE FLANGE
			OVERHEAD DOOR	WDP	WOOD PANELIN
	F	OHD	OVERHEAD DOOR		
	FLOOR DRAIN	OD	OUTSIDE DIAMETER	WR	WATER-RESIST
FD FDTN					

	4 REFERENCE SYMBOLS	5	6 MATERIAL SYMBOLS		7	
NCRETE	DRAWING TITLE		EARTHWORK			WOOLPERT
ERED METAL BUILDING		DRAWING REFERENCE NUMBER     DRAWING TITLE	EARTH OR COMPACT FILL	GRANULAR FILL	ROCK	ARCHITECTURE   ENGINEERING   GEOSPATIAL 4454 IDEA CENTER BOULEVARD DAYTON, OH 45430-1500 937.461.5660
SQUARE FOOT SQUARE INCH	EXTERIOR ELEVATIONS	SCALE OF DRAWING	CONCRETE	LT. WEIGHT CONCRETE	MORTAR	E ATE OF OKHAN
EL DISPENSER HLORIDE	A1 A-201	DRAWING REFERENCE NUMBER     DRAWING SHEET NUMBER	MASONRY			DOBROZSI 10802 10802 10802 10802
			СМИ	BRICK		James Julian Dobrozsi License #10602 Expiration Date: 12/31/2023
ASE CEILING PLAN	BUILDING SECTION	<ul> <li>DRAWING REFERENCE NUMBER</li> <li>DRAWING SHEET NUMBER</li> </ul>	STONE			ISSUED FOR CONSTRUCTION
	A1 SIM	<ul> <li>DRAWING REFERENCE NUMBER</li> <li>DRAWING SHEET NUMBER</li> </ul>	METAL			
			METAL @ LARGE SCALE			
VING	WALL SECTION	END OF SECTION     DRAWING REFERENCE NUMBER	FINISH	ROUGH	BLOCKING	DESCRIPTIO
CRETE	A-311	DRAWING SHEET NUMBER	GLASS         SMALL SCALE	LARGE SCALE	GLASS BLOCK	DATE ISS
ITCHEN FLOORING		- END OF SECTION			GLASS BLOCK	
ER BASE EAM METAL ROOF TEEL	DETAIL/ENLARGED PLAN	DRAWING REFERENCE NUMBER     DRAWING SHEET NUMBER	LOOSE OR BATT	RIGID	SPRAY FOAM	c PARK DISTRICT
			FINISHES			Follow the Park District
	DRAWING SYMBOLS		ELEVATION INDICATIONS			RKICI RK
TTOM 9 GROOVE	COLUMN GRID LINES	MISCELLANEOUS SYMBOLS         F.D.       FLOOR DRAIN	GLASS	CONCRETE	SIDING	RK DIS - TER R PARI
FACE CRETE DNRY		Image: Provide the second s				E AAR URE
IL - JE DIPENSER	ROOM SYMBOL         STORAGE         ROOM NAME	GRAPHIC SYMBOLS WORK POINT	DOOR CONVENTIONS			
	101     ROOM NUMBER       DOOR TAG     REVISION     WALL TYPE	DATUM POINT POINT ELEVATION		EXIST. DOOR TO BE REMOVED	BI-FOLD DOOR	RMONT M PA HRYN S HRYN S SHEN RD. N, OH 45122
ED OTHERWISE	Image: 101     Image: 101 <td>SHADED PORTION IS THE SIDE CONSIDERED</td> <td>NEW SINGLE DOOR</td> <td>NEW PAIR OF DOORS</td> <td>POCKET DOOR</td> <td>CLER KATH KATH KATH KATH CLER KATH COLER COSHEN,</td>	SHADED PORTION IS THE SIDE CONSIDERED	NEW SINGLE DOOR	NEW PAIR OF DOORS	POCKET DOOR	CLER KATH KATH KATH KATH CLER KATH COLER COSHEN,
DSITION TILE ICED TILE L BASE	$\frac{1}{\sqrt{101}} \qquad \frac{1}{\sqrt{101}} \qquad \frac{1}$	- 0' - 0"	DOUBLE ACTING DOOR	DOOR WITH EMERGENCY RELEASE HARDWA	BARN DOOR	PROJECT NO: 10018702 DATE ISSUED: 08/02/2023 DESIGNED BY: J. DOBROZSI
COVERING	SHEET NUMBERING SYSTEM	SHEET TYPE DESIGNATOR 0 - GENERAL - SYMBOLS/LEGEND & NOTES	DOOR WITH 180 DEGREE SWING	ACCORDION FOLDING DOOR		DRAWN BY: G. RODDY CHECKED BY: J. DOBROZSI
ET E LING	C - CIVIL L - LANDSCAPE S - STRUCTURAL A - ARCHITECTURAL I - INTERIORS	1 - PLANS 2 - BUILDING ELEVATIONS 3 - BUILDING SECTIONS & WALL SECTIONS 4 - LARGE SCALE VIEWS 5 - DETAILS				A SYMBOLS AND ABBREVIATIONS
STANT F E FABRIC	F - FIRE PROTECTION P - PLUMBING M - MECHANICAL E - ELECTRICAL DISCIPLINE DESIGNATOR - (DASH) or D (DEMOLITION)	6 - SCHEDULES & DIAGRAMS 7 - USER DEFINED - FLOOR FINISH PLANS 8 - USER DEFINED - LIFE SAFETY PLANS 9- 3D REPRESENTATIONS — <u>SHEET SEQUENCE NUMBER</u> 01 THROUGH 99				
		01 11110001133				<u>SHEET NO:</u> A-001



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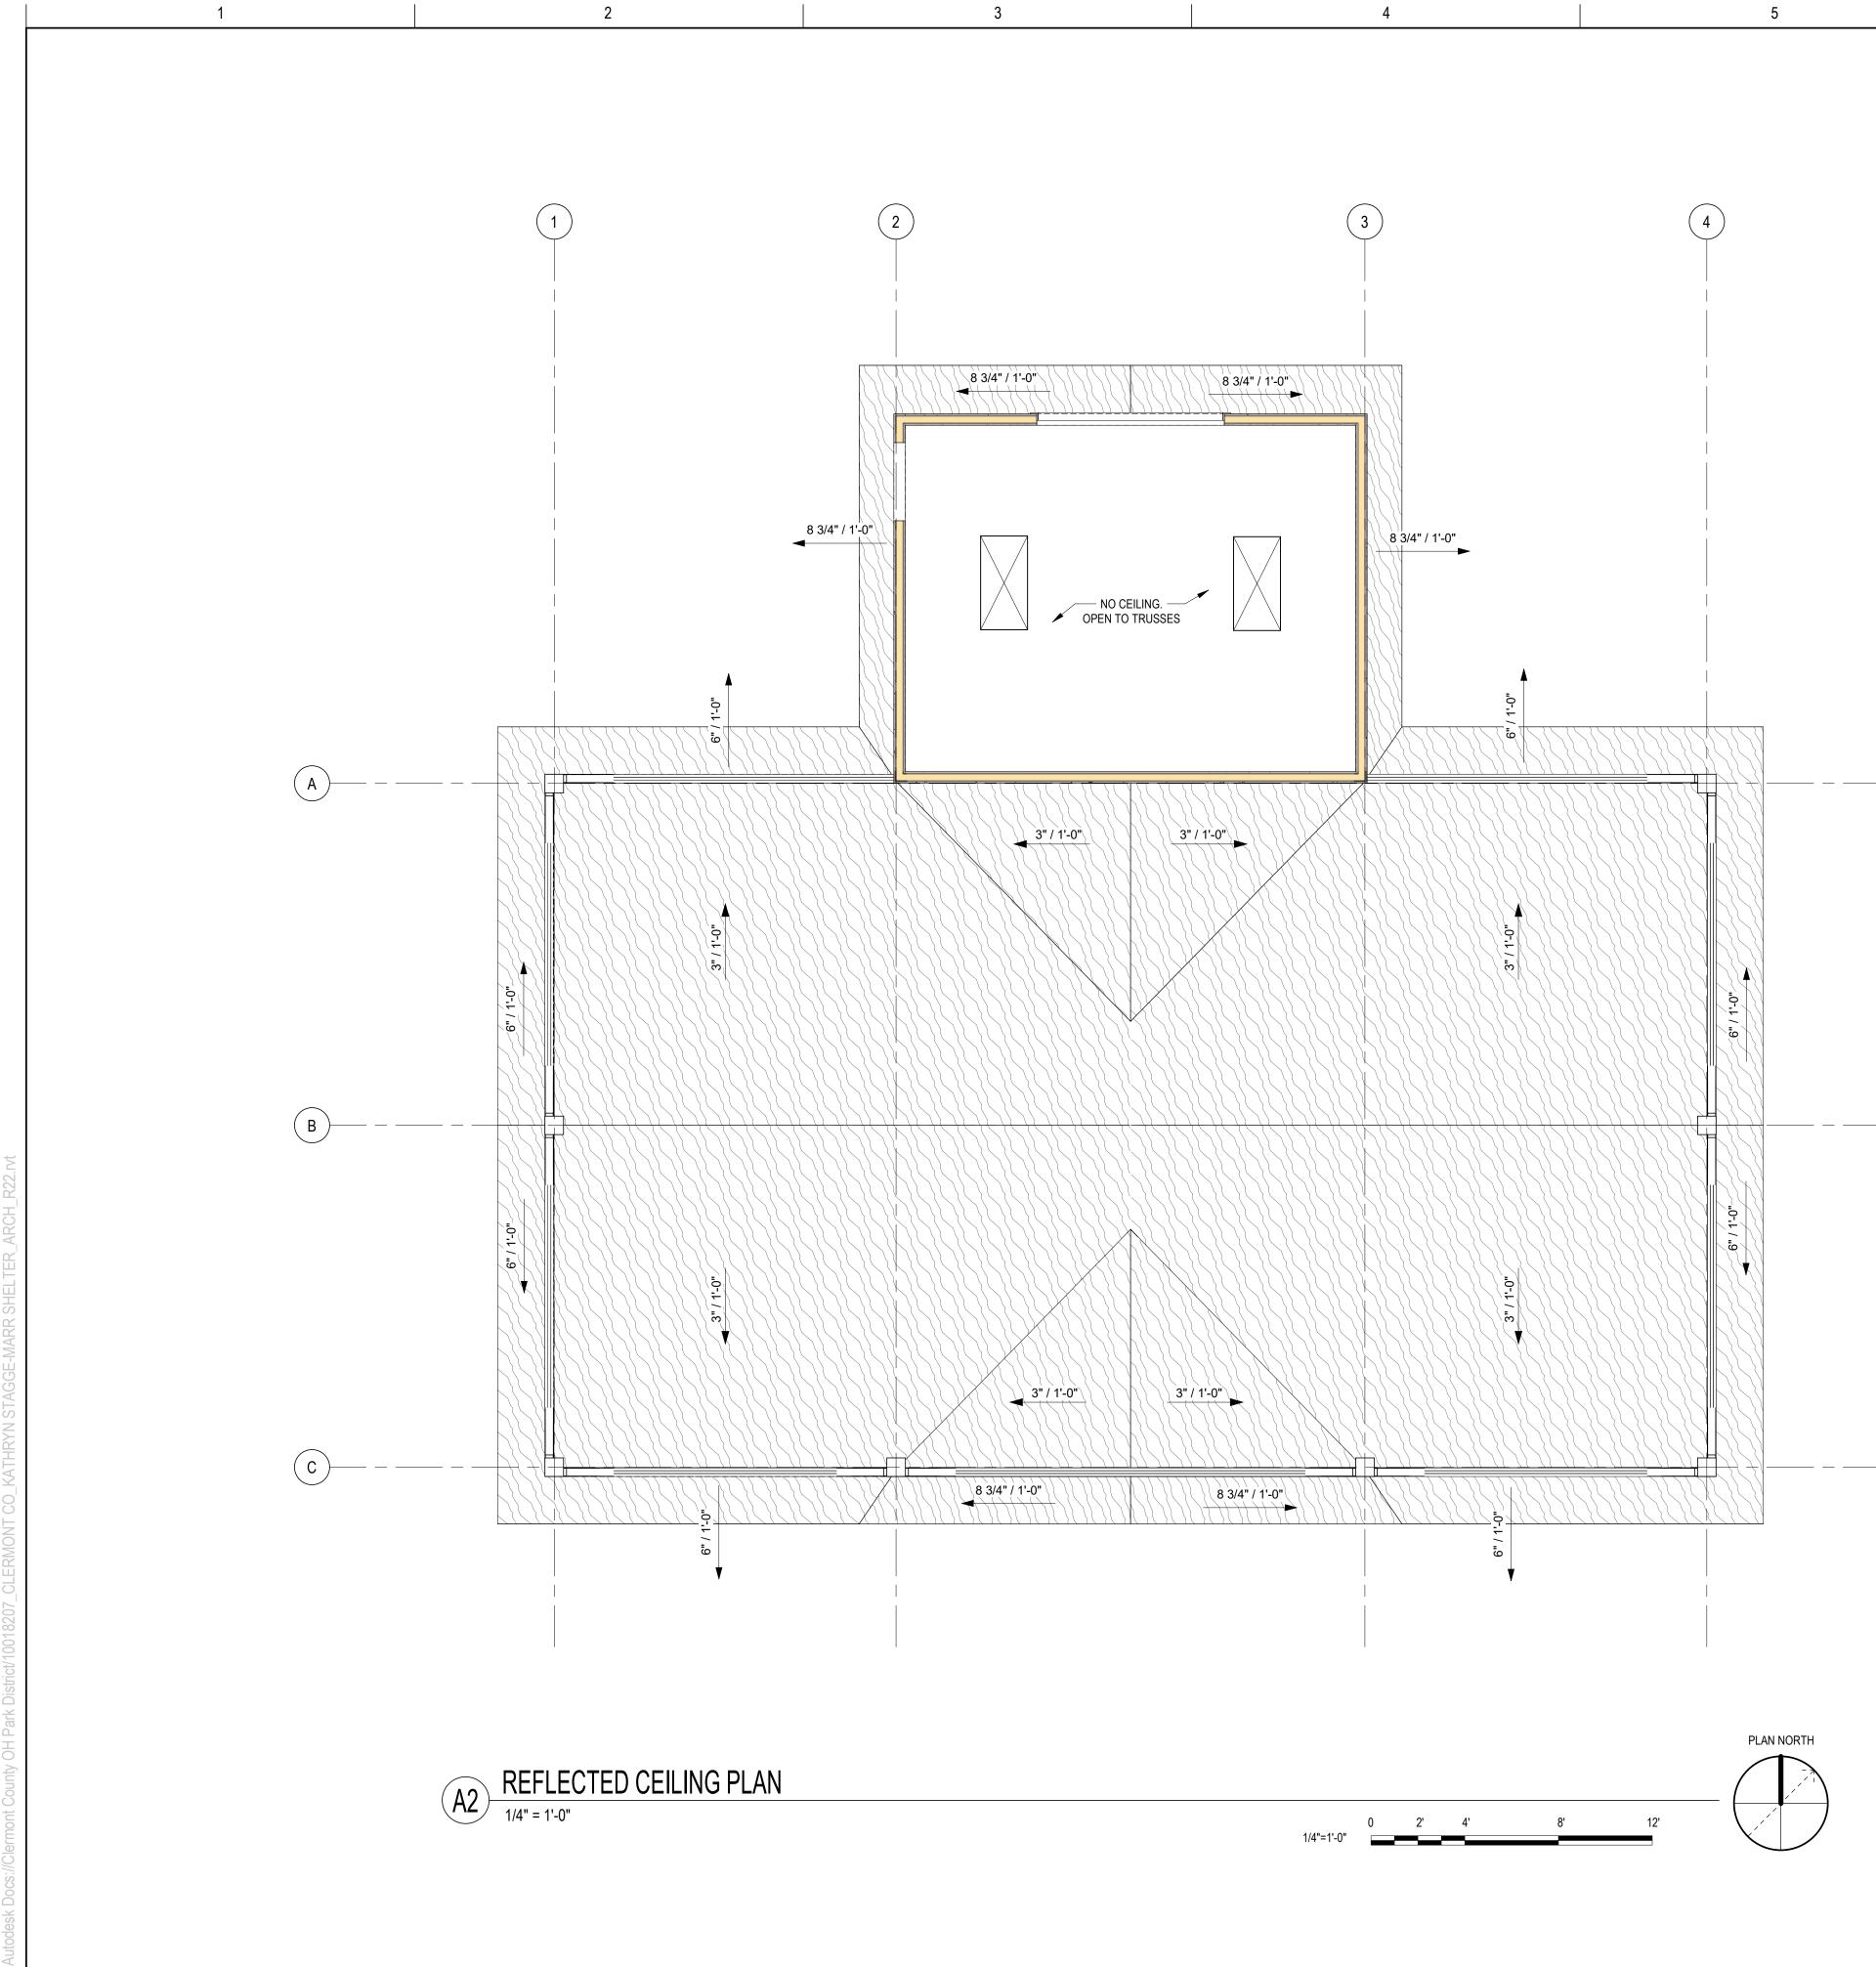


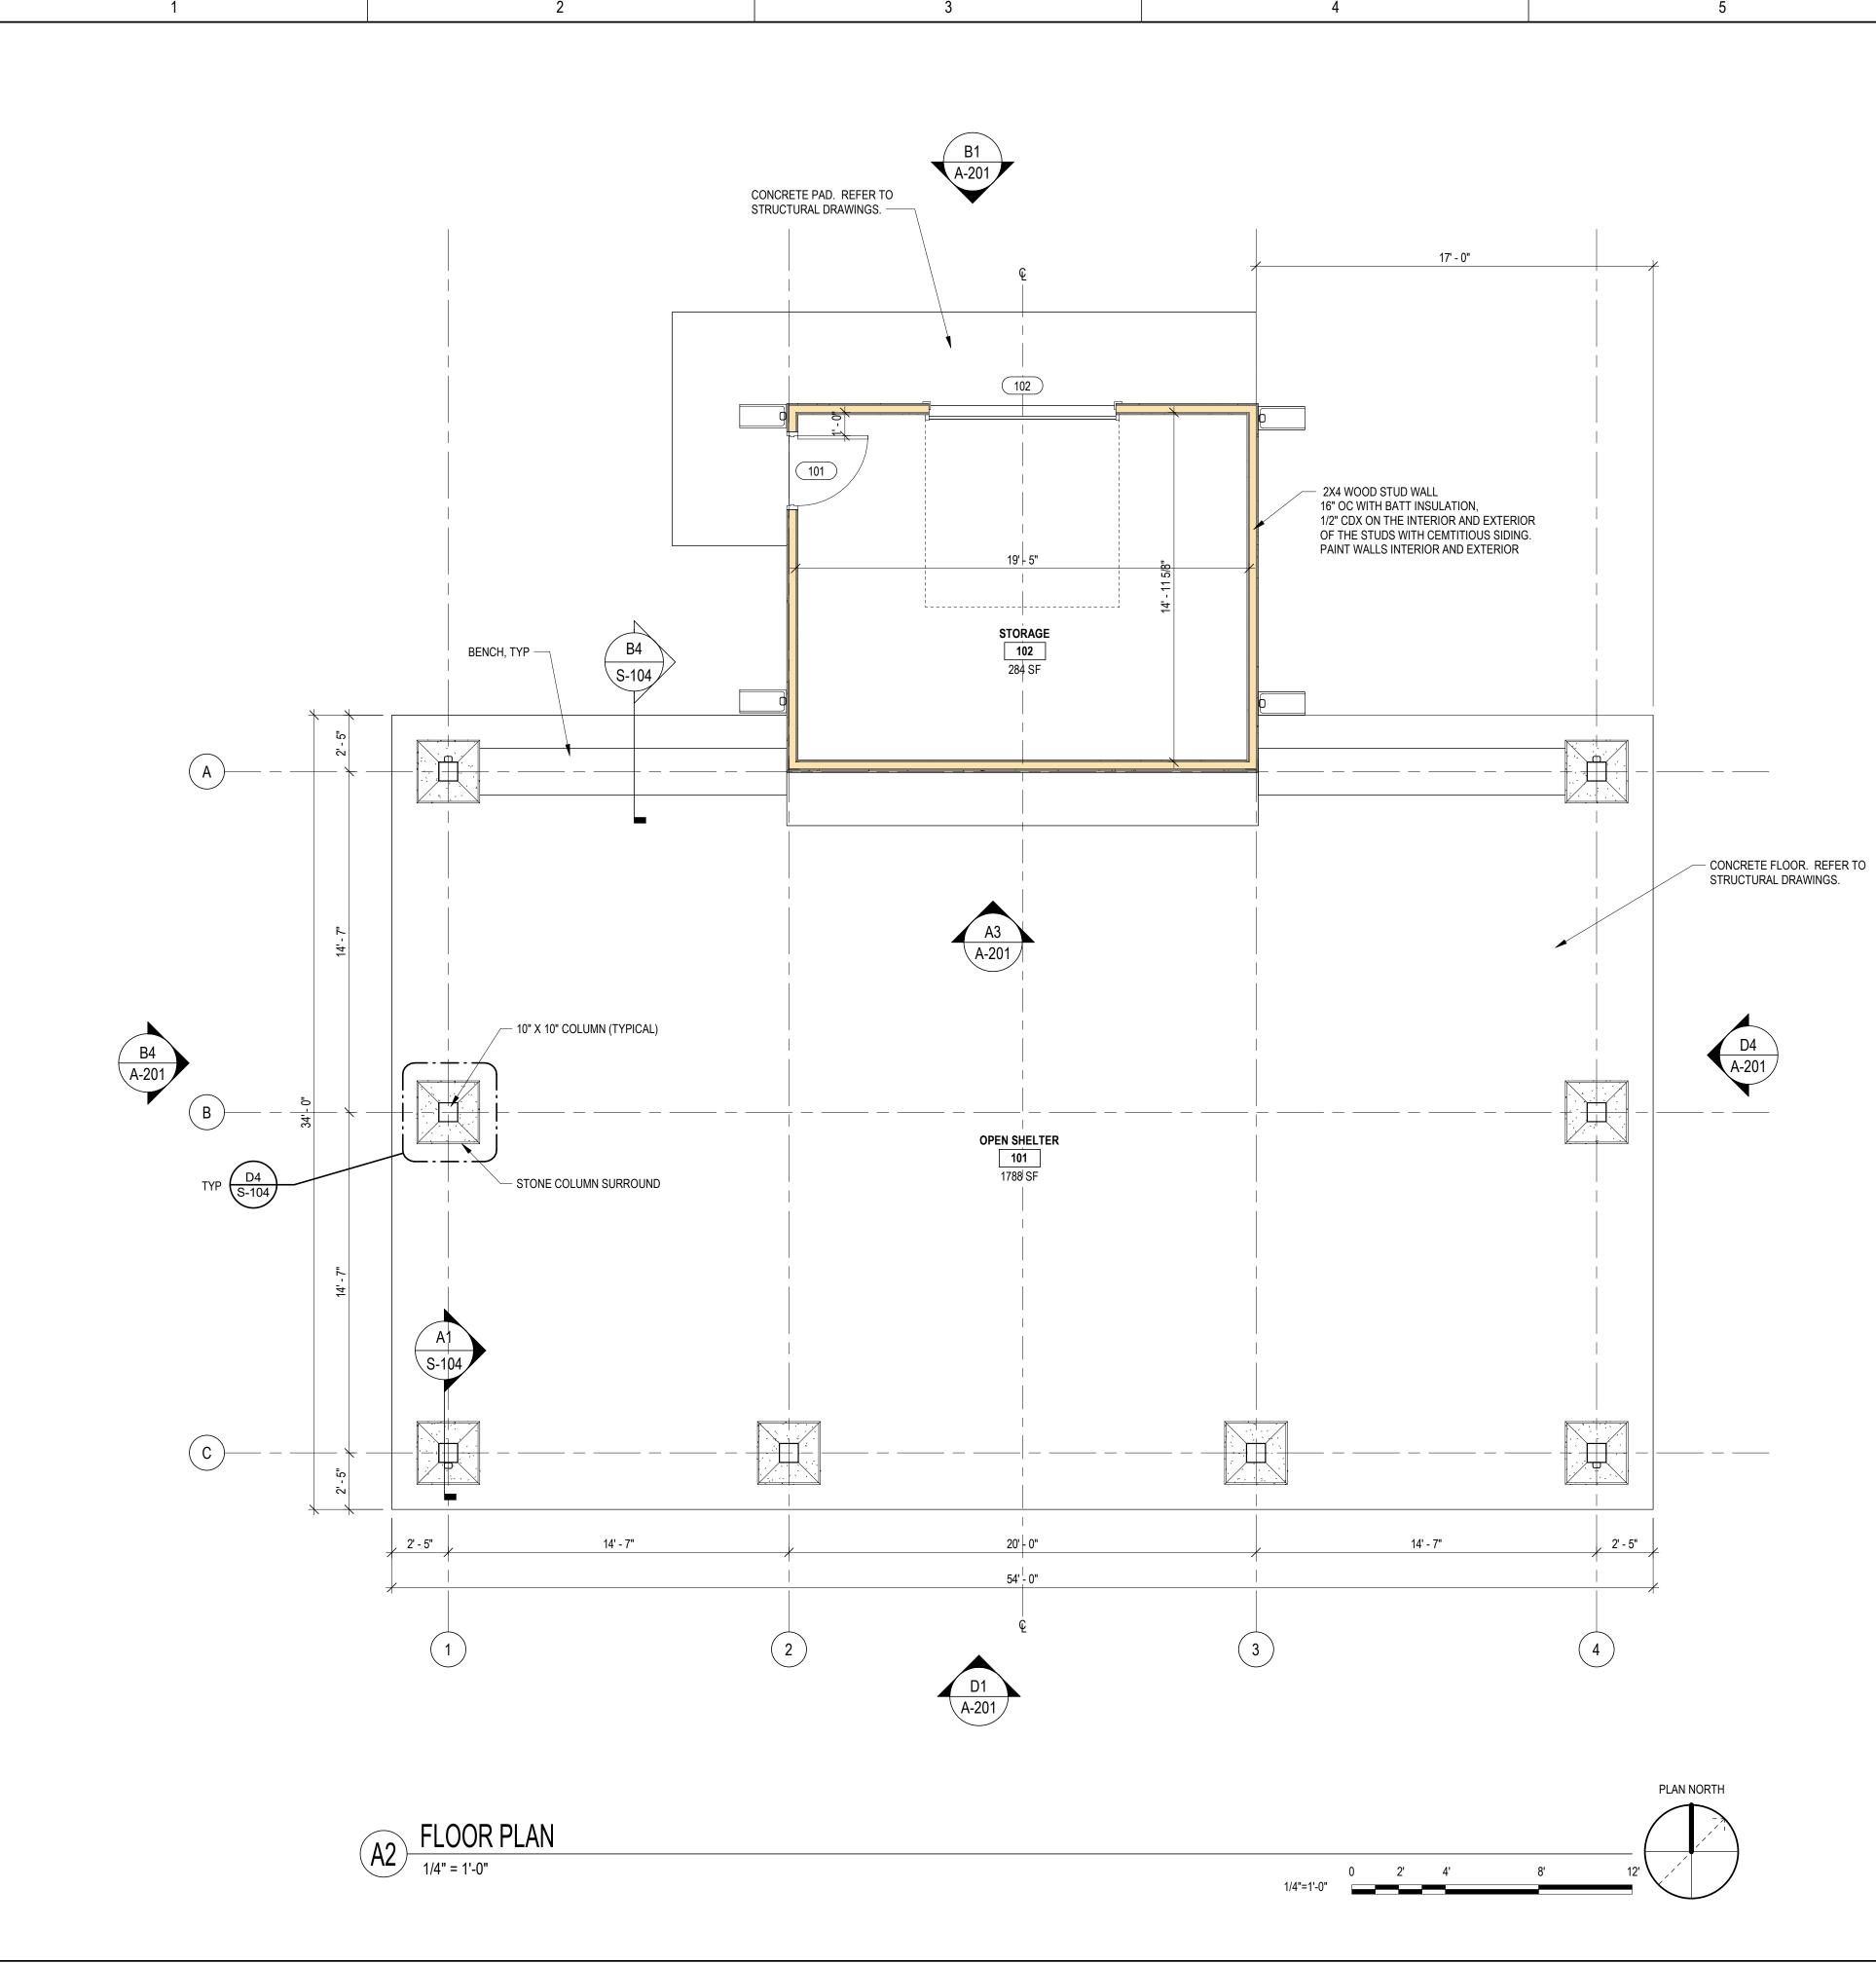


### **GENERAL SHEET NOTES:**

- A. ALL DIMENSIONS TO BE VERIFIED IN FIELD PRIOR TO CONSTRUCTION. NOTIFY ARCHITECT OF ALL DISCREPANCIES PRIOR TO STARTING WORK.
- B. ALL DIMENSIONS ARE FACE OF MASONRY, POURED CONCRETE, OR FACE OF
- STUD (WOOD OR METAL), U.N.O.C. ALL INTERIOR DOOR FRAMES SHALL BE LOCATED A DISTANCE OF SIX INCHES FROM THROAT RETURN TO THE CLOSEST ADJACENT PERPENDICULAR
- PARTITION, U.N.O. D. PROVIDE SOLID BLOCKING/BACKING IN-WALL CAVITIES AT ALL WALL MOUNTED CASEWORK, FIXTURES, EQUIPMENT AND SHELVING. REFER TO TYPICAL
- PARTITION AND BACK PLATE DETAILS FOR ADDITIONAL INFORMATION.
   E. REFER TO MEP AND FIRE PROTECTION DRAWINGS FOR MOUNTING HEIGHTS OF SWITCHES, OUTLETS, ALARMS AND ALL SURFACE MOUNTED COMPONENTS.
- F. ALL MASONRY DIMENSIONS ARE NOMINAL, U.N.O.
- G. REFER TO SHEET A-601 FOR DOOR SCHEDULE AND DETAILS.H. REFER TO SHEET S-101 FOR FOUNDATION PLAN.
- I. REFER TO SHEET S-102 FOR SLAB PLAN.
- J. REFER TO SHEET S-103 FOR MASONRY PLAN.
- K. REFER TO SHEET S-104 FOR STRUCTURAL DETAILS.L. REFER TO SHEET E-101 FOR ELECTRICAL PLANS.







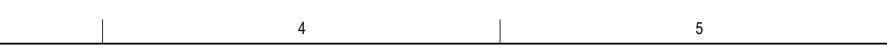







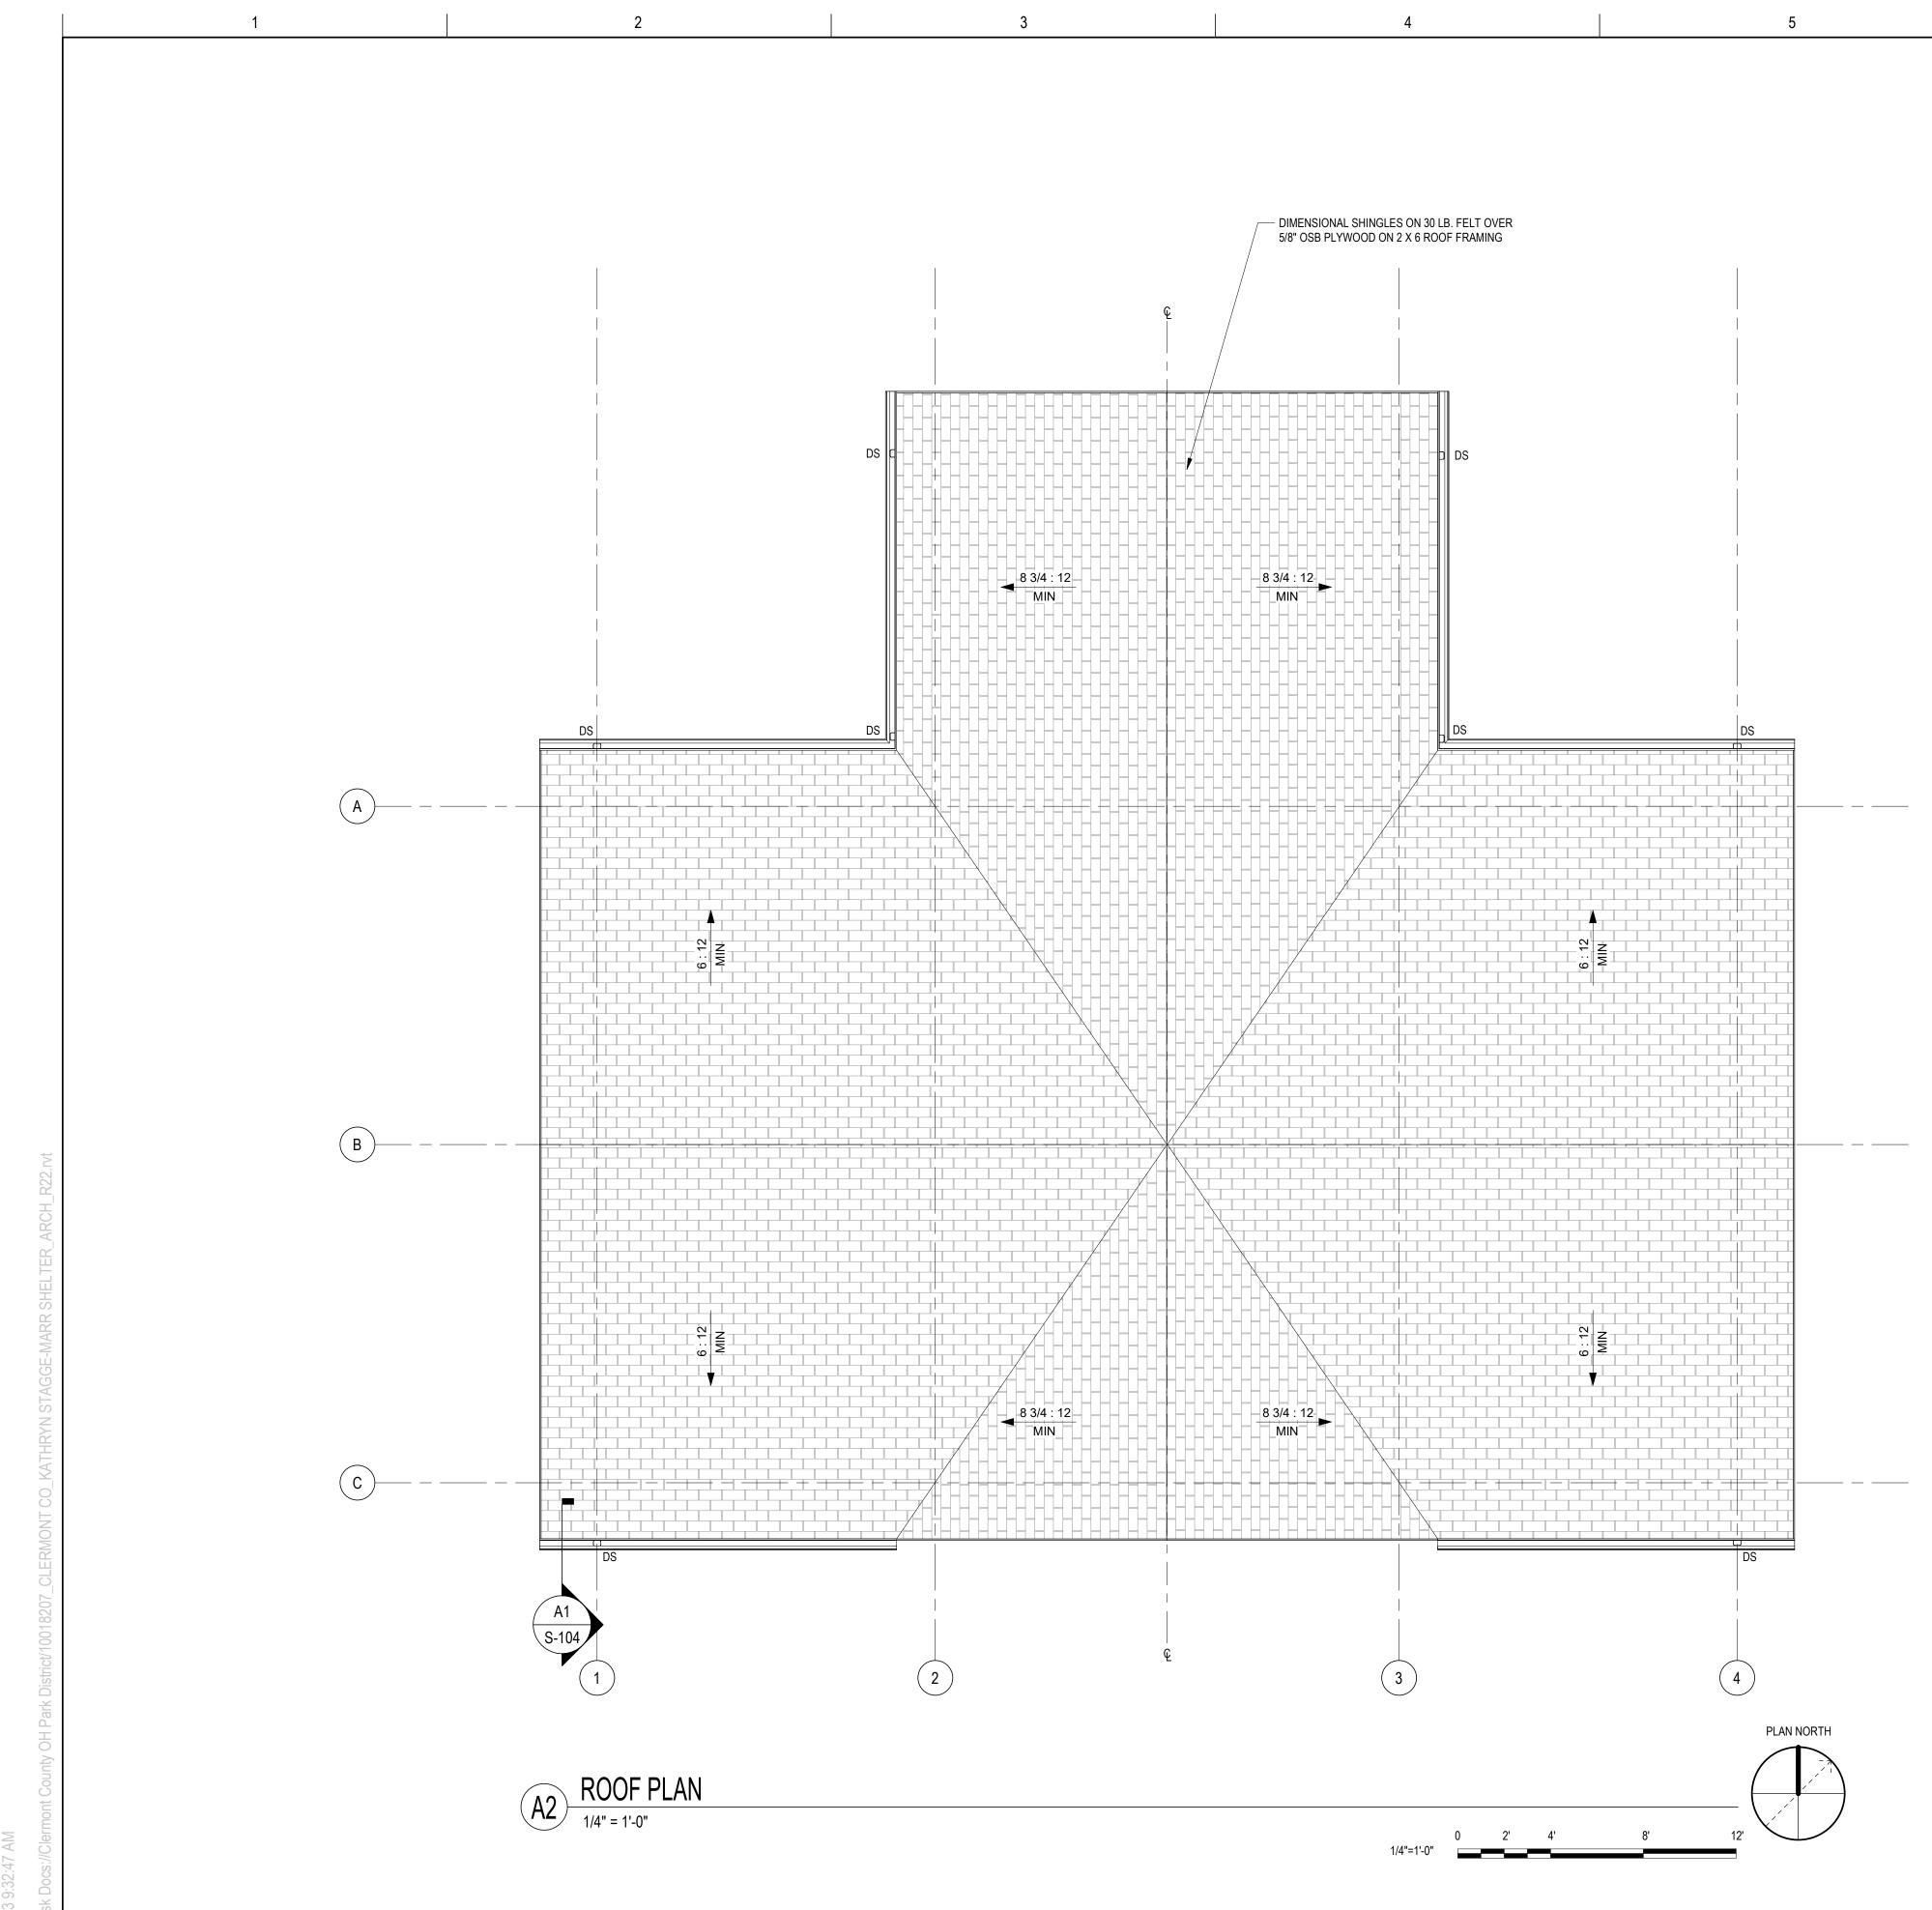

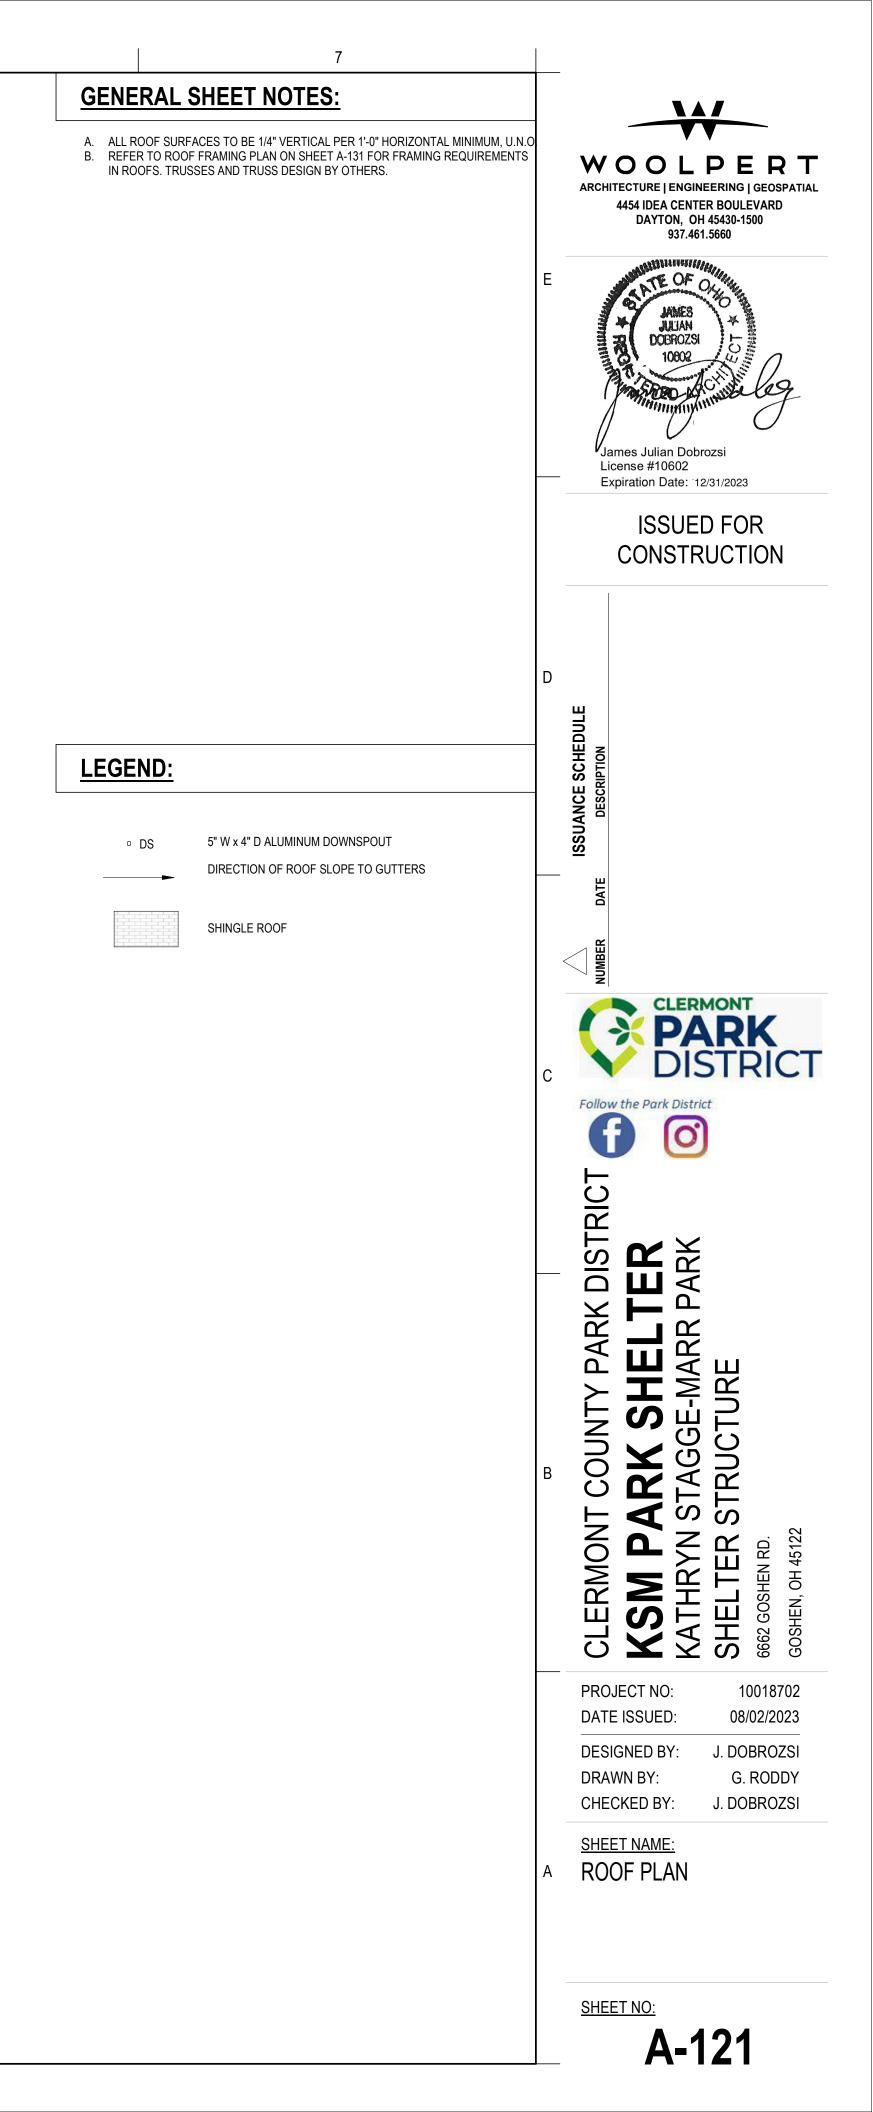

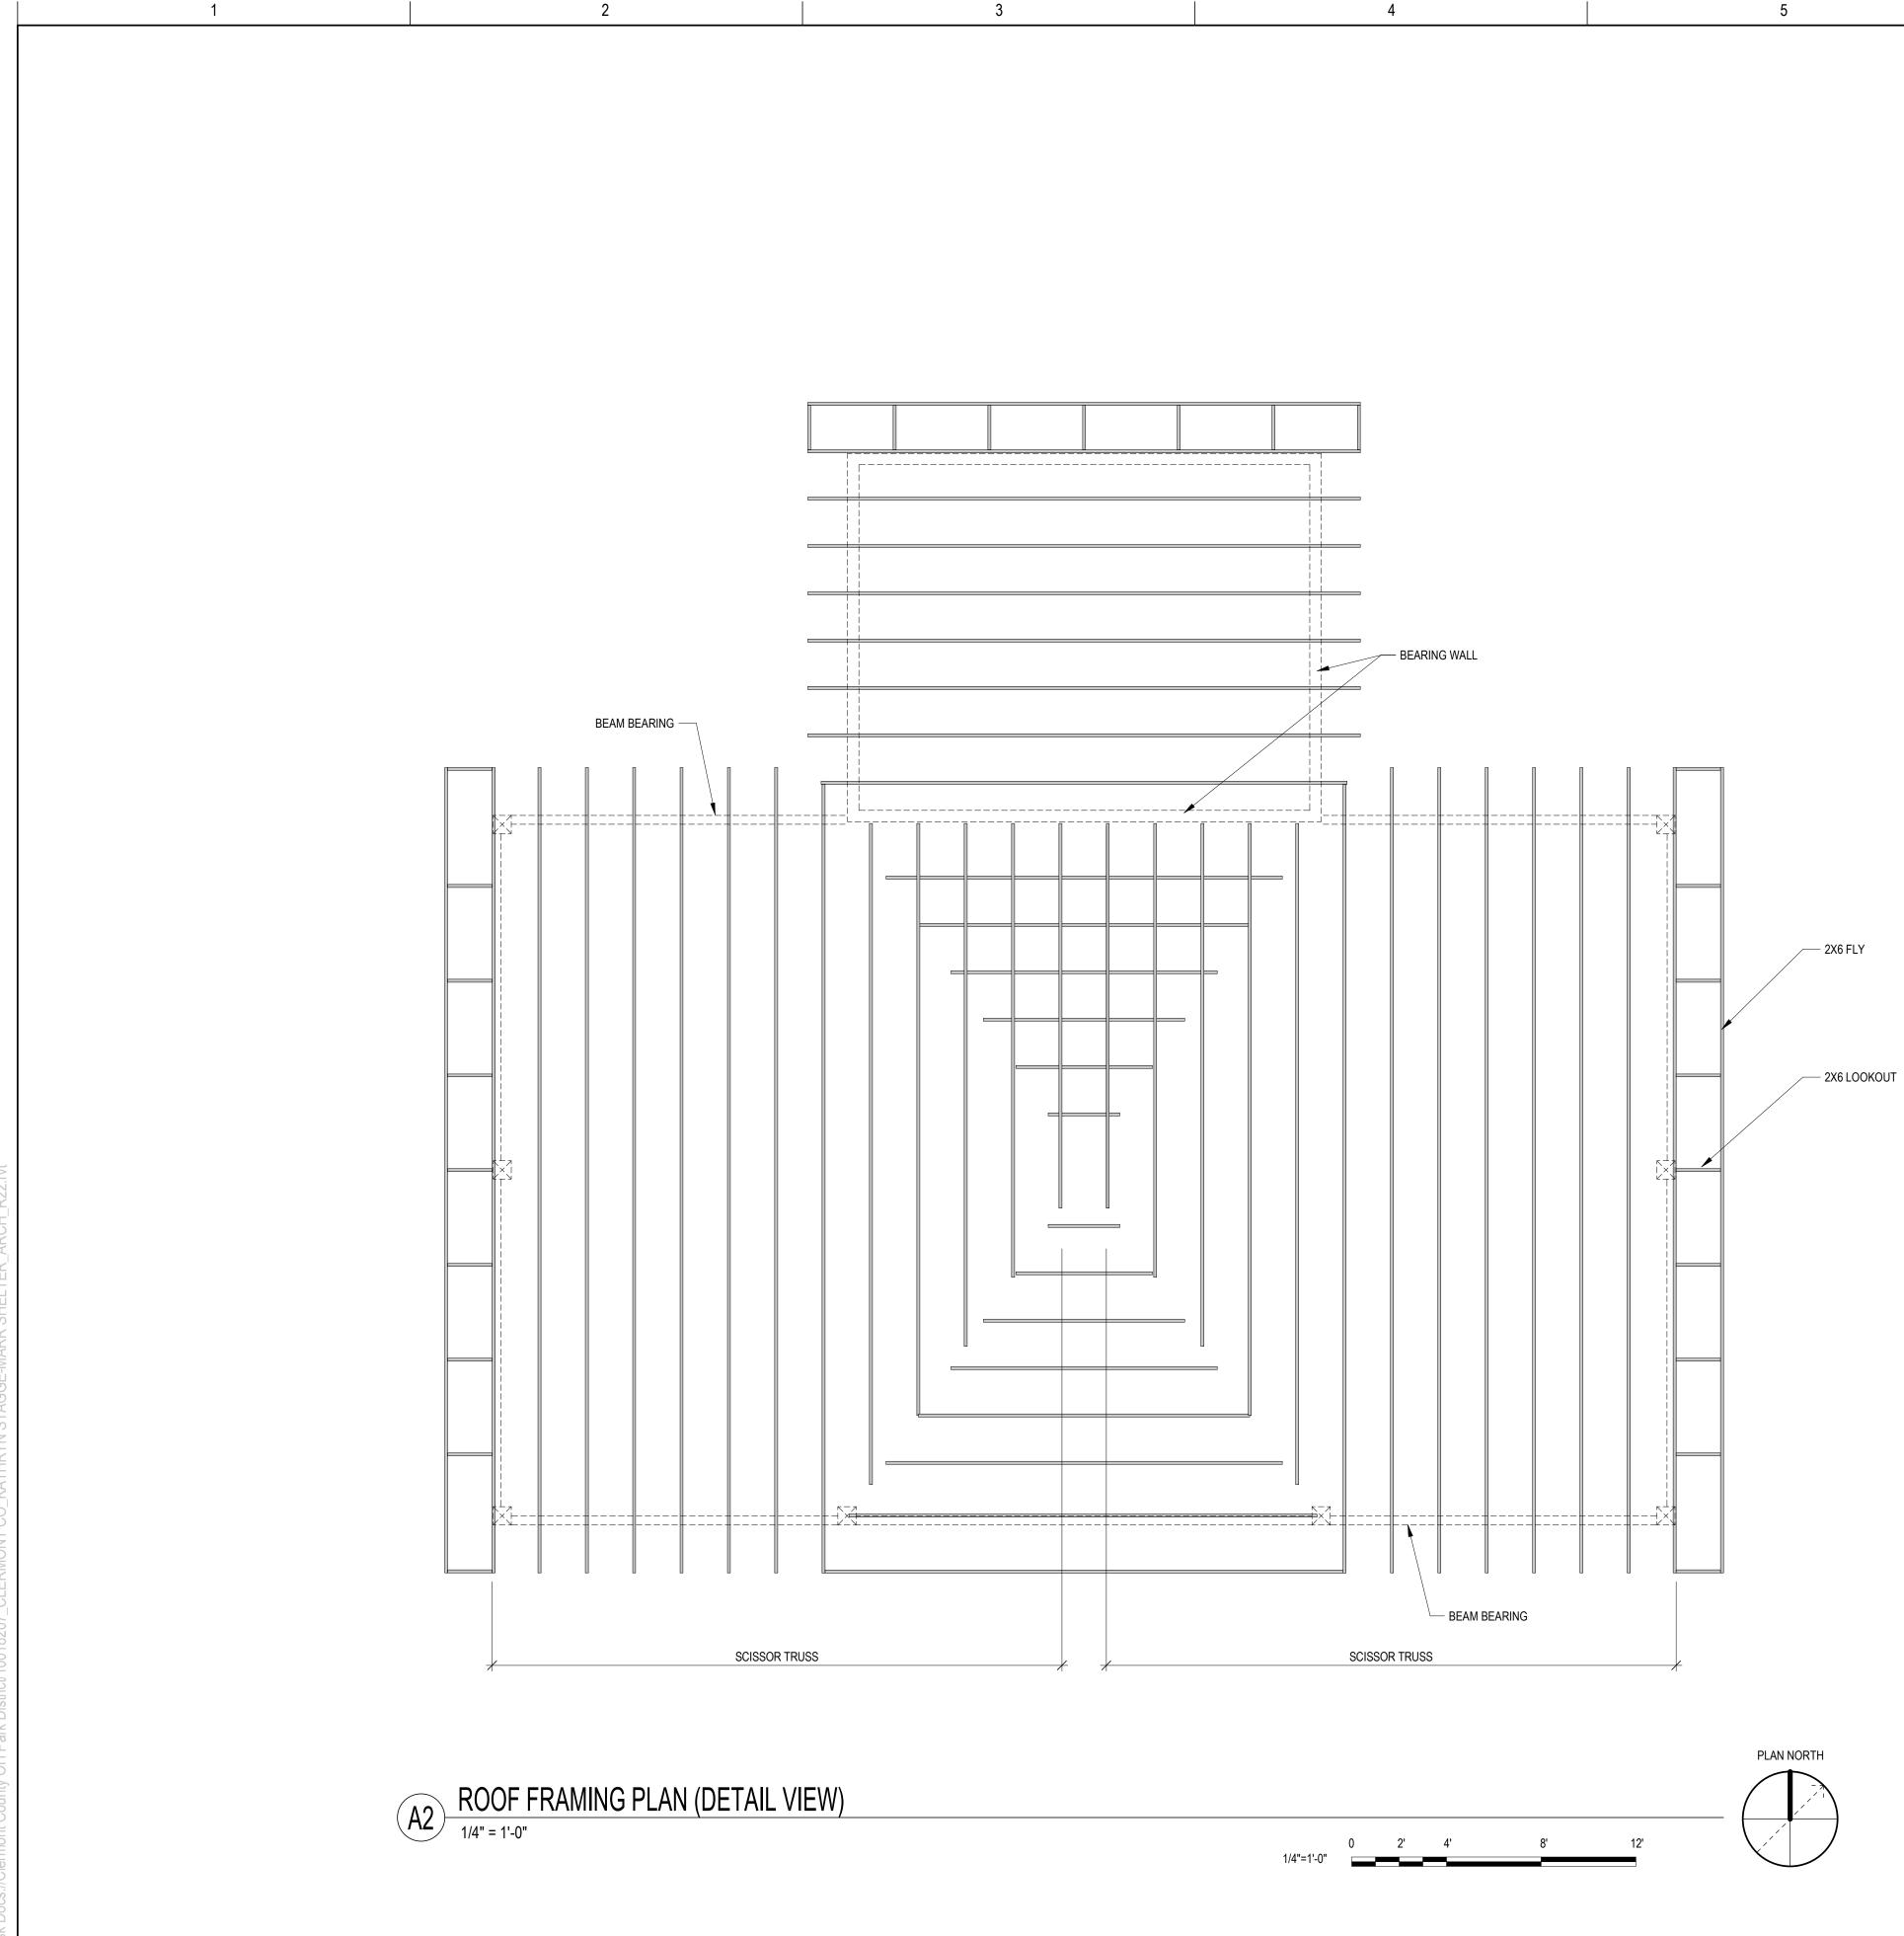



**GENERAL SHEET NOTES:** A. TRUSSES AND TRUSS DESIGN BY OTHERS. DRAWING IS FOR REFERENCE ONLY. WOOLPERT ARCHITECTURE | ENGINEERING | GEOSPATIAL 4454 IDEA CENTER BOULEVARD DAYTON, OH 45430-1500 937.461.5660 ATEOA JAMES JULIAN DOBROZSI 10802 James Julian Dobrozsi License #10602 Expiration Date: 12/31/2023 **ISSUED FOR** CONSTRUCTION ISSUANCE SCHEDULE DISTRICT Follow the Park District Ø 6 CLERMONT COUNTY PARK DISTRICT KARMARK SHELTER KATHRYN STAGGE-MARR PARK SHELTER STRUCTURE SHELTER STRUCTURE , OH 45122 ΤĒΝ. GOSF 10018702 PROJECT NO: 08/02/2023 DATE ISSUED: J. DOBROZSI DESIGNED BY: G. RODDY DRAWN BY: J. DOBROZSI CHECKED BY: <u>SHEET NAME:</u> ROOF FRAMING PLAN SHEET NO: A-131

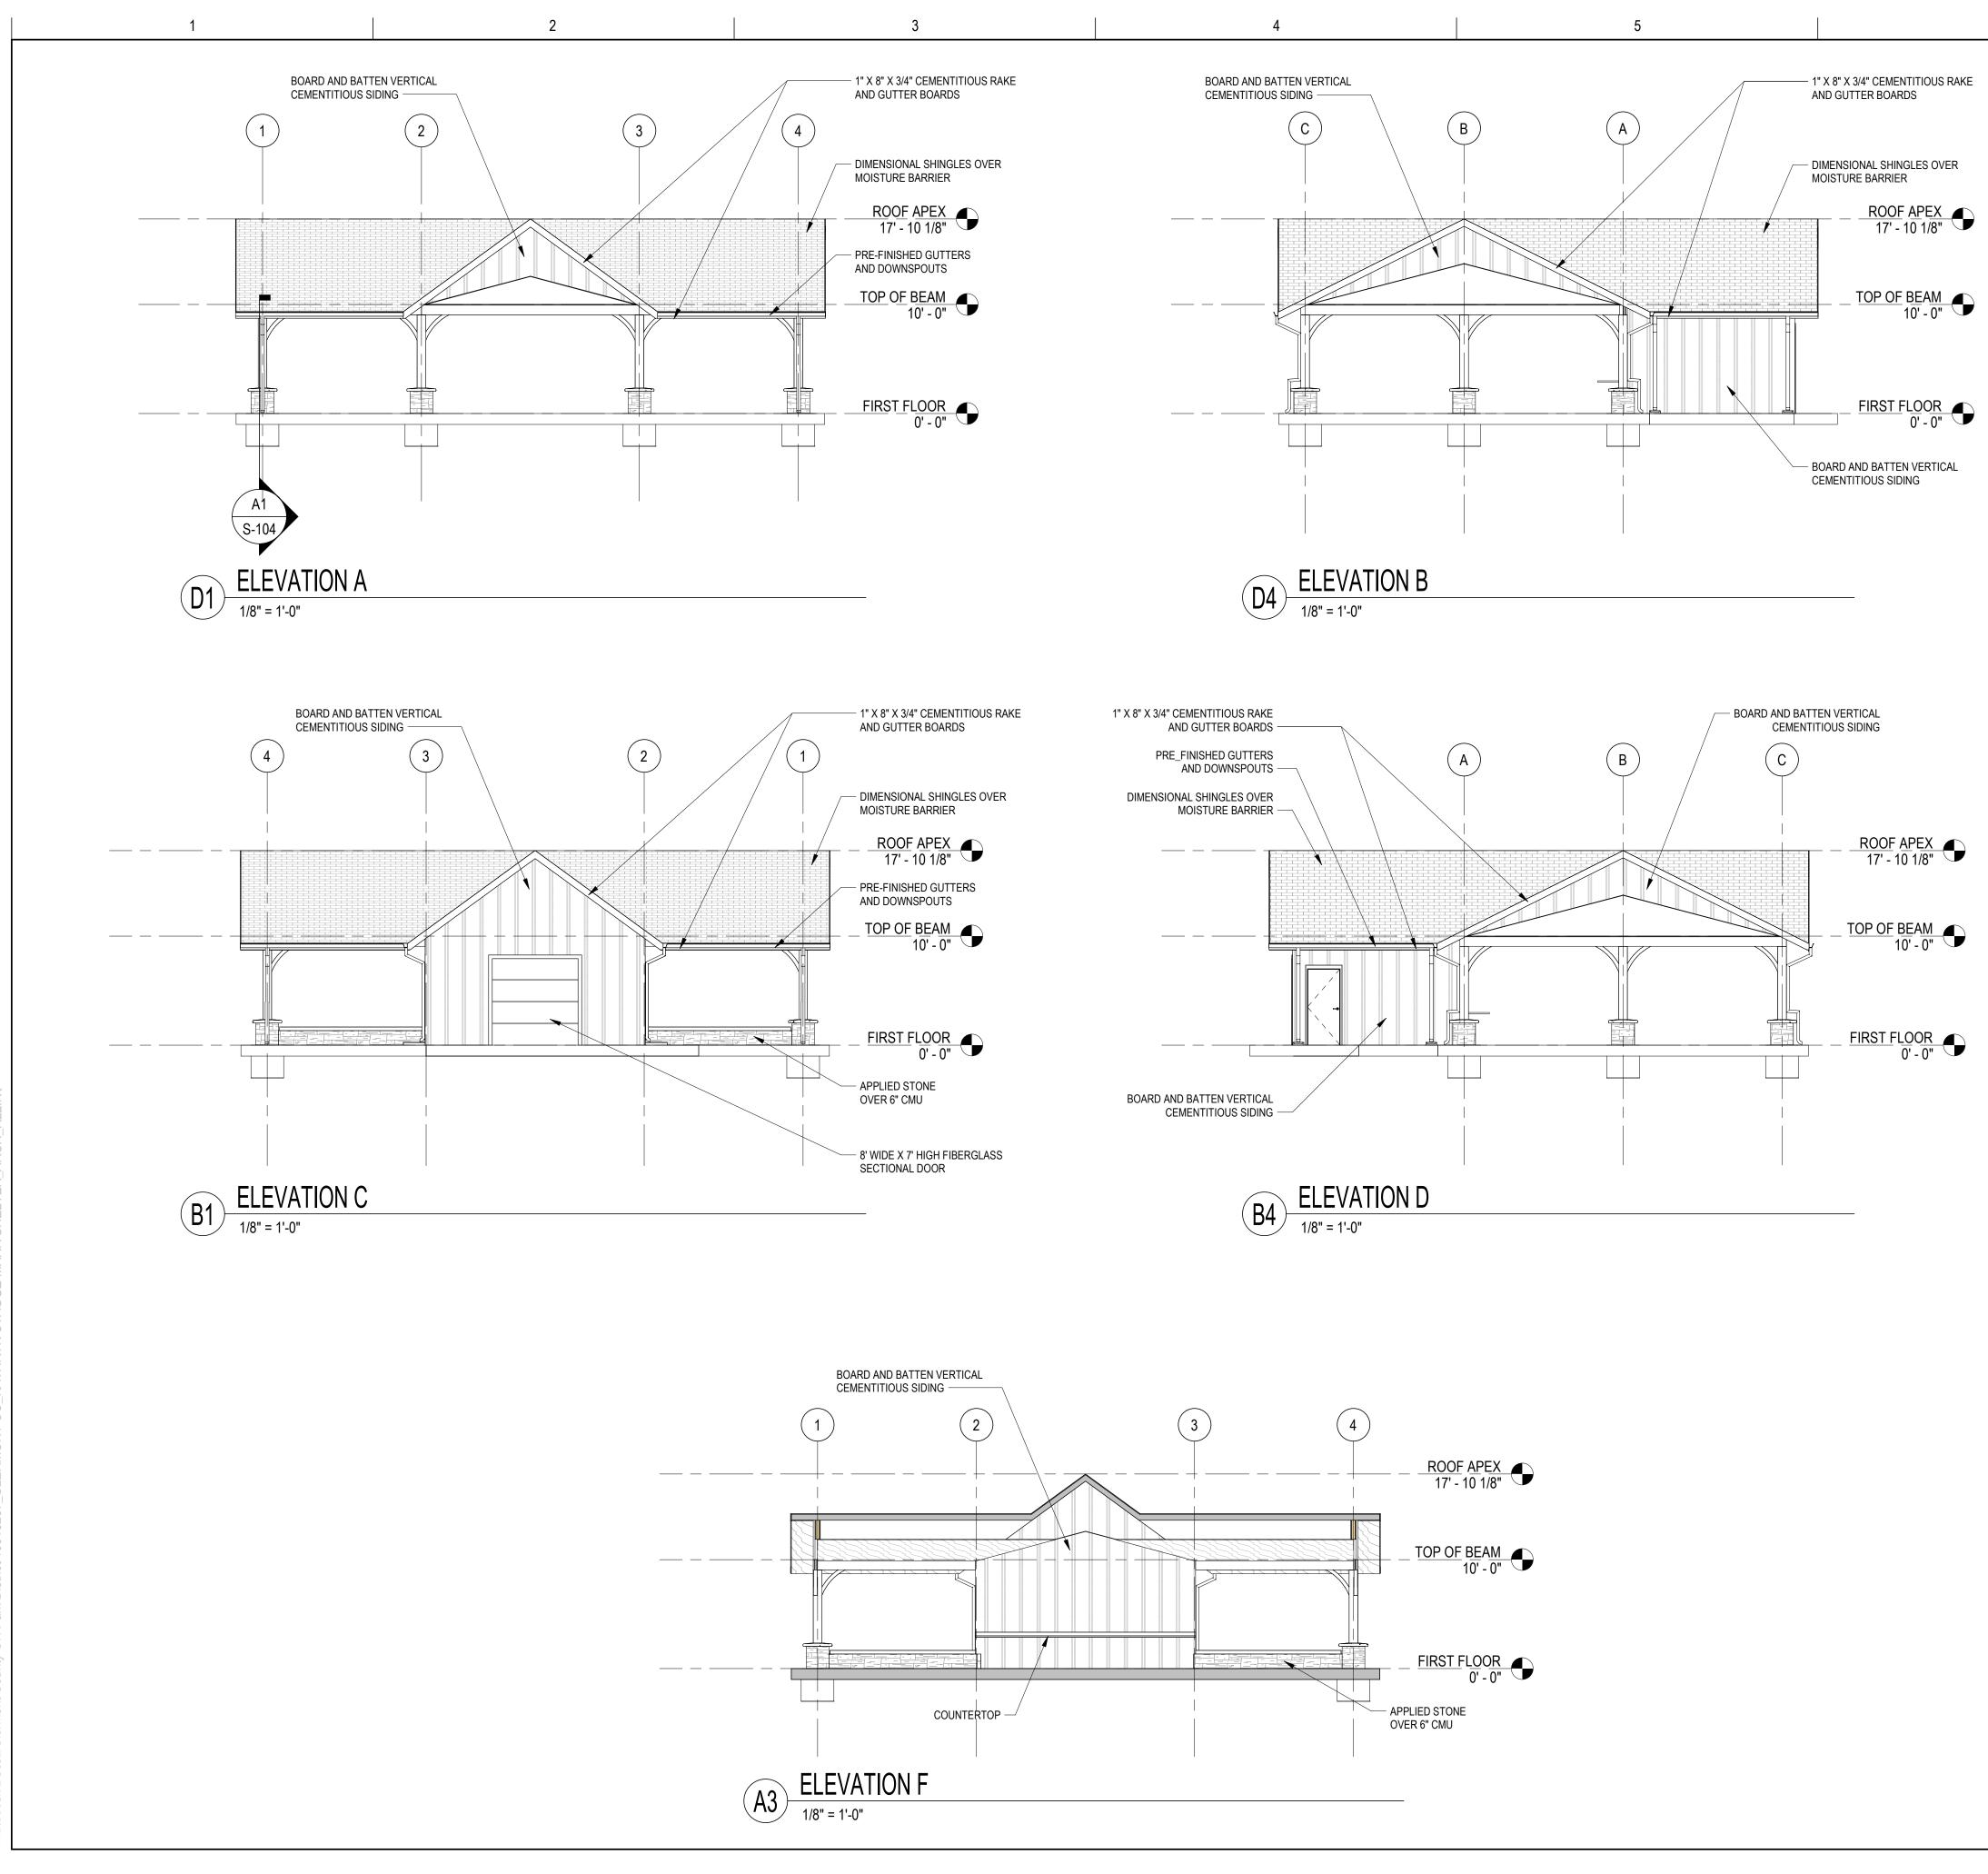

Autodesk Docs://Clermont County OH Park District/10018207 CLERMONT CO KATHRYN STAGGE-MARR SHELTER ARCH I


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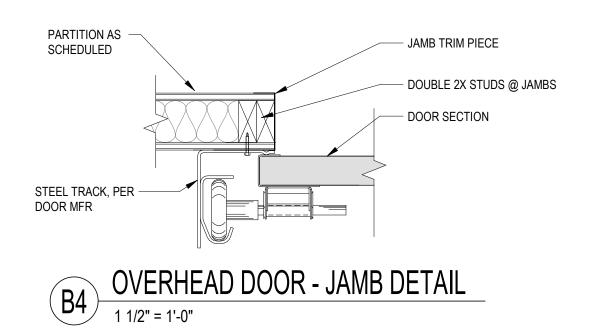


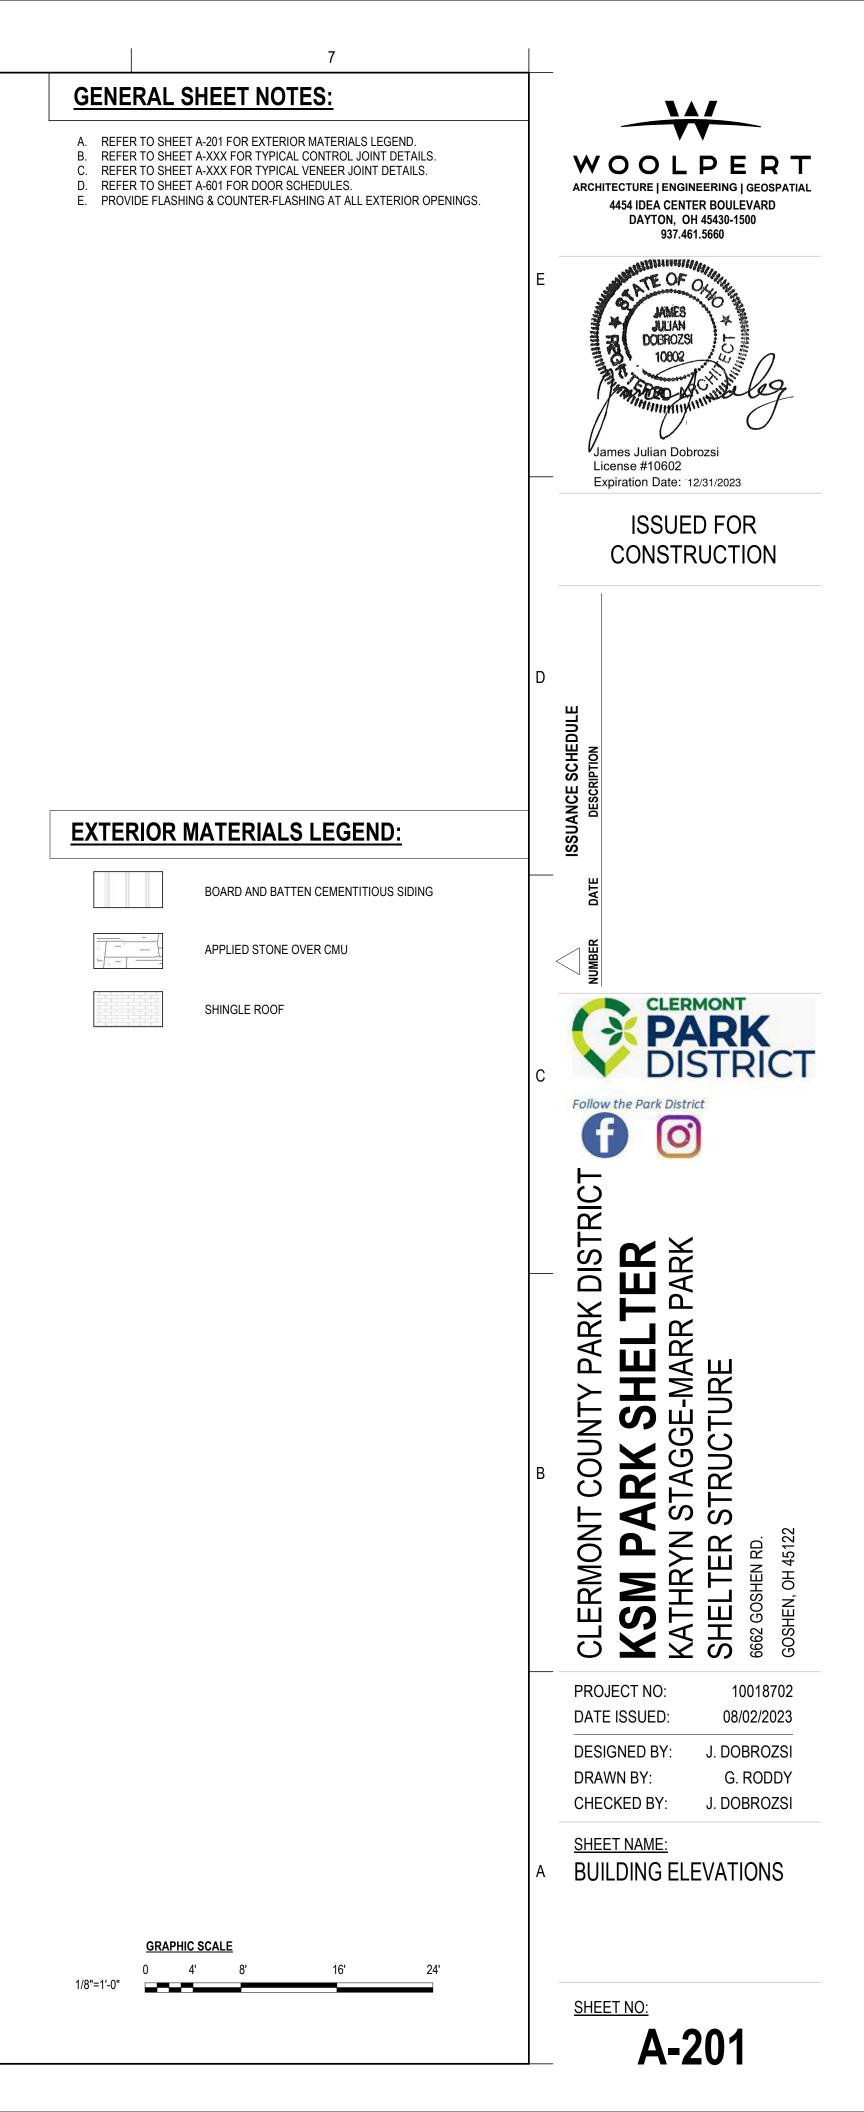
4	5	
	0	

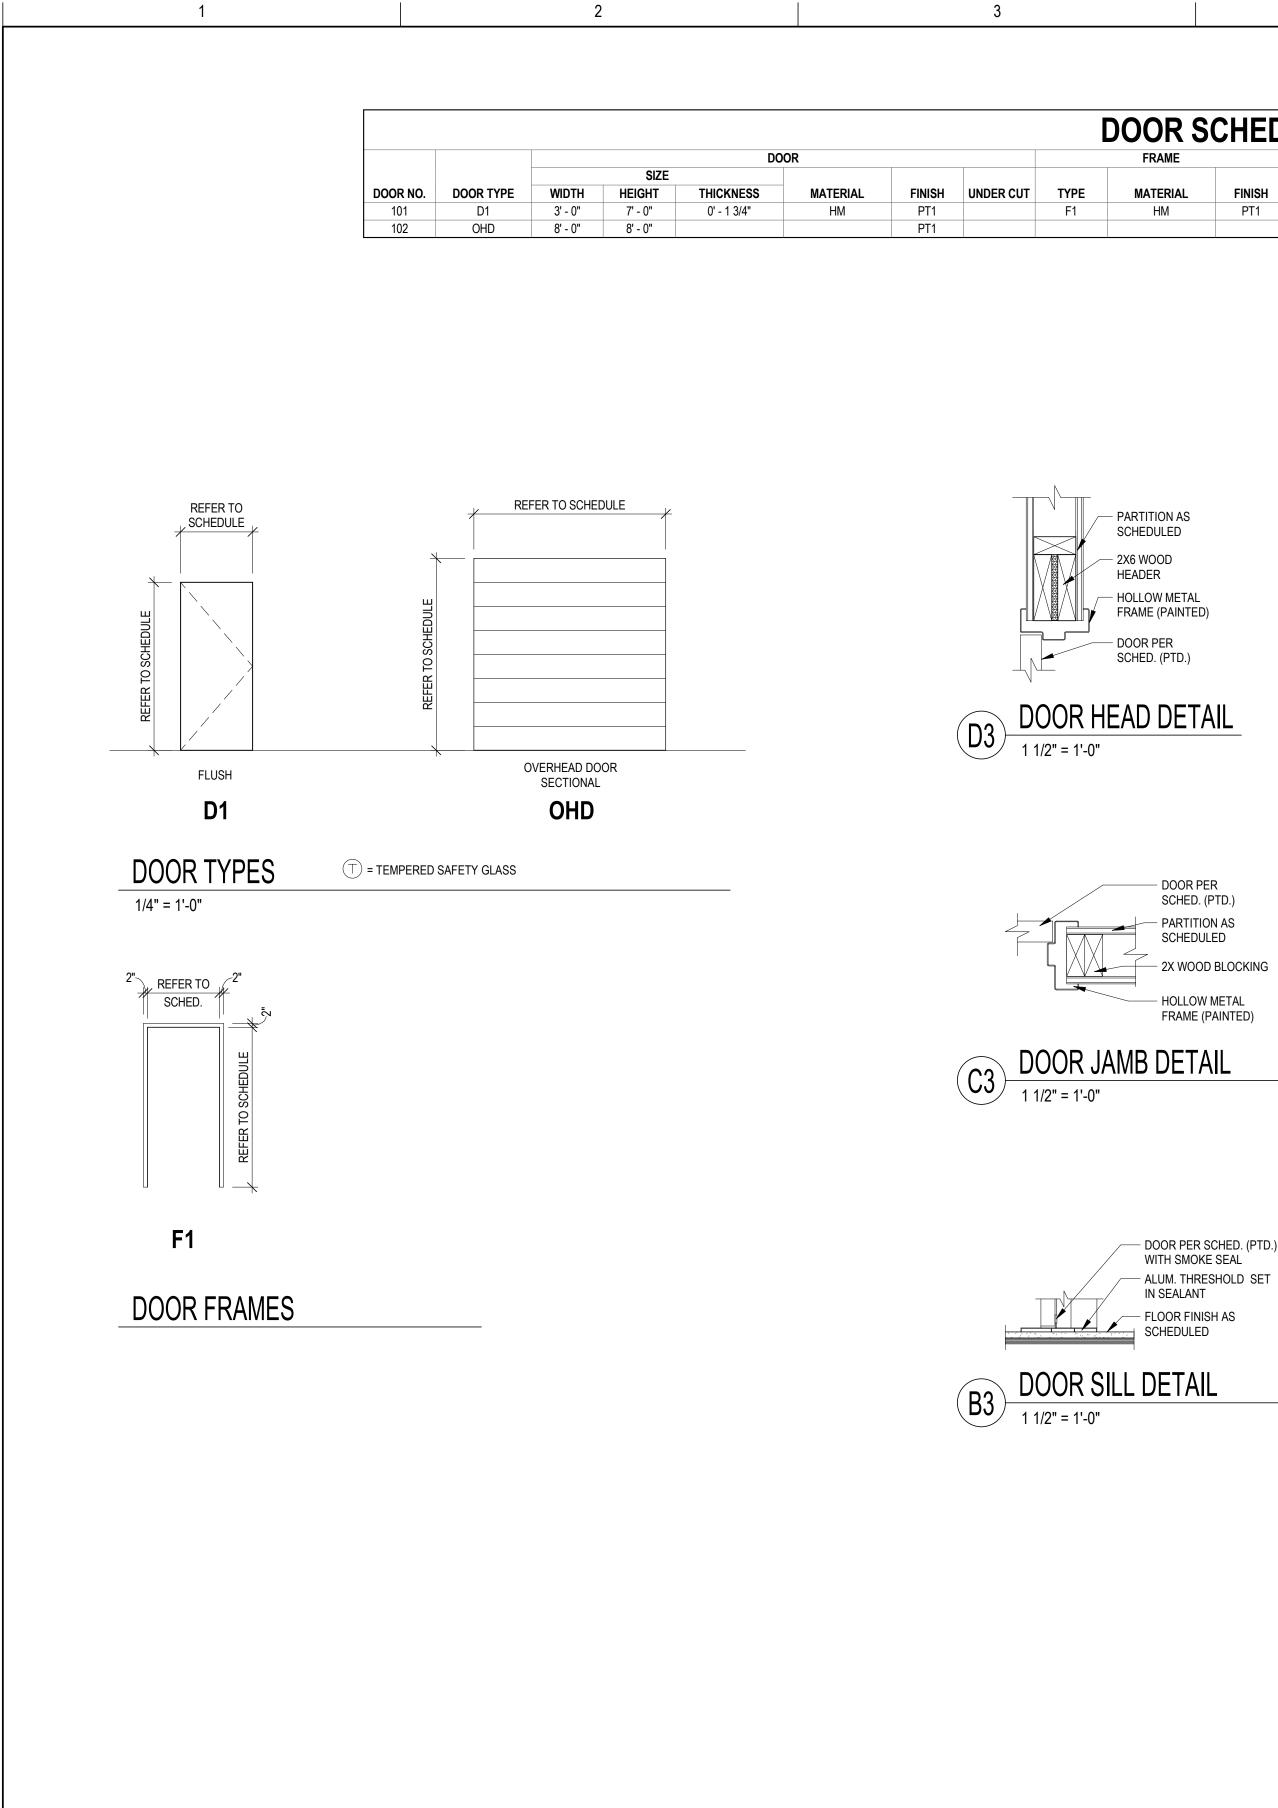DOOR SCHEDULE									
FRAME			RA	RATING		DETAILS			
ТҮРЕ	MATERIAL	FINISH	STC	FIRE	HEAD	JAMB	SILL	HARDWARE NO.	DOOR NOTES
F1	HM	PT1	N/A	NONE	D3	C3	B3		
					C4	B4	A4		





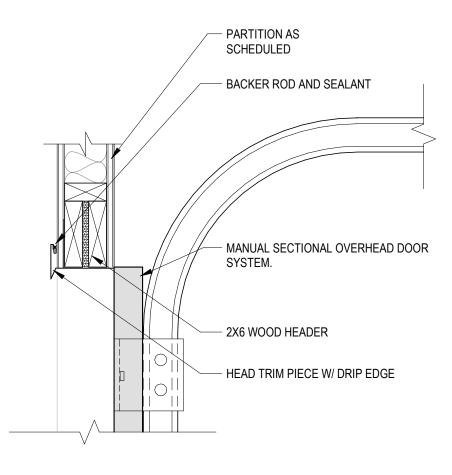


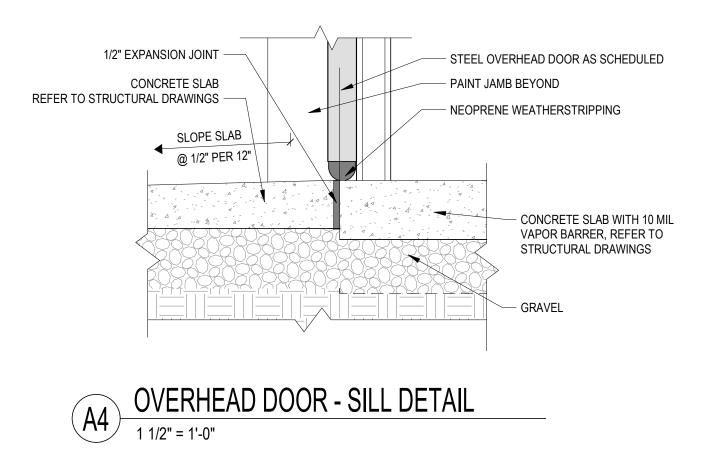

### **GENERAL SHEET NOTES:**

A. REFER TO SPECIFICATIONS FOR ADDITIONAL DOOR HARDWARE REQUIREMENTS, INCLUDING SUBMITTAL REQUIREMENTS.

WOOLPERT ARCHITECTURE | ENGINEERING | GEOSPATIAL 4454 IDEA CENTER BOULEVARD DAYTON, OH 45430-1500 937.461.5660 JAMES JULIAN DOBROZSI 10802 James Julian Dobrozsi License #10602 Expiration Date: 12/31/2023 **ISSUED FOR** CONSTRUCTION ISSUANCE SCHEDULE DISTRIC Follow the Park District G 0 E U CLERMONT COUNTY PARK DISTRICT KSM PARK SHELTER KATHRYN STAGGE-MARR PARK SHELTER STRUCTURE G662 GOSHEN RD. l 45122 Ю GOS PROJECT NO: 10018702 08/02/2023 DATE ISSUED: DESIGNED BY: J. DOBROZSI G. RODDY DRAWN BY: CHECKED BY: J. DOBROZSI <u>SHEET NAME:</u> DOOR SCHEDULE & TYPES SHEET NO: A-601

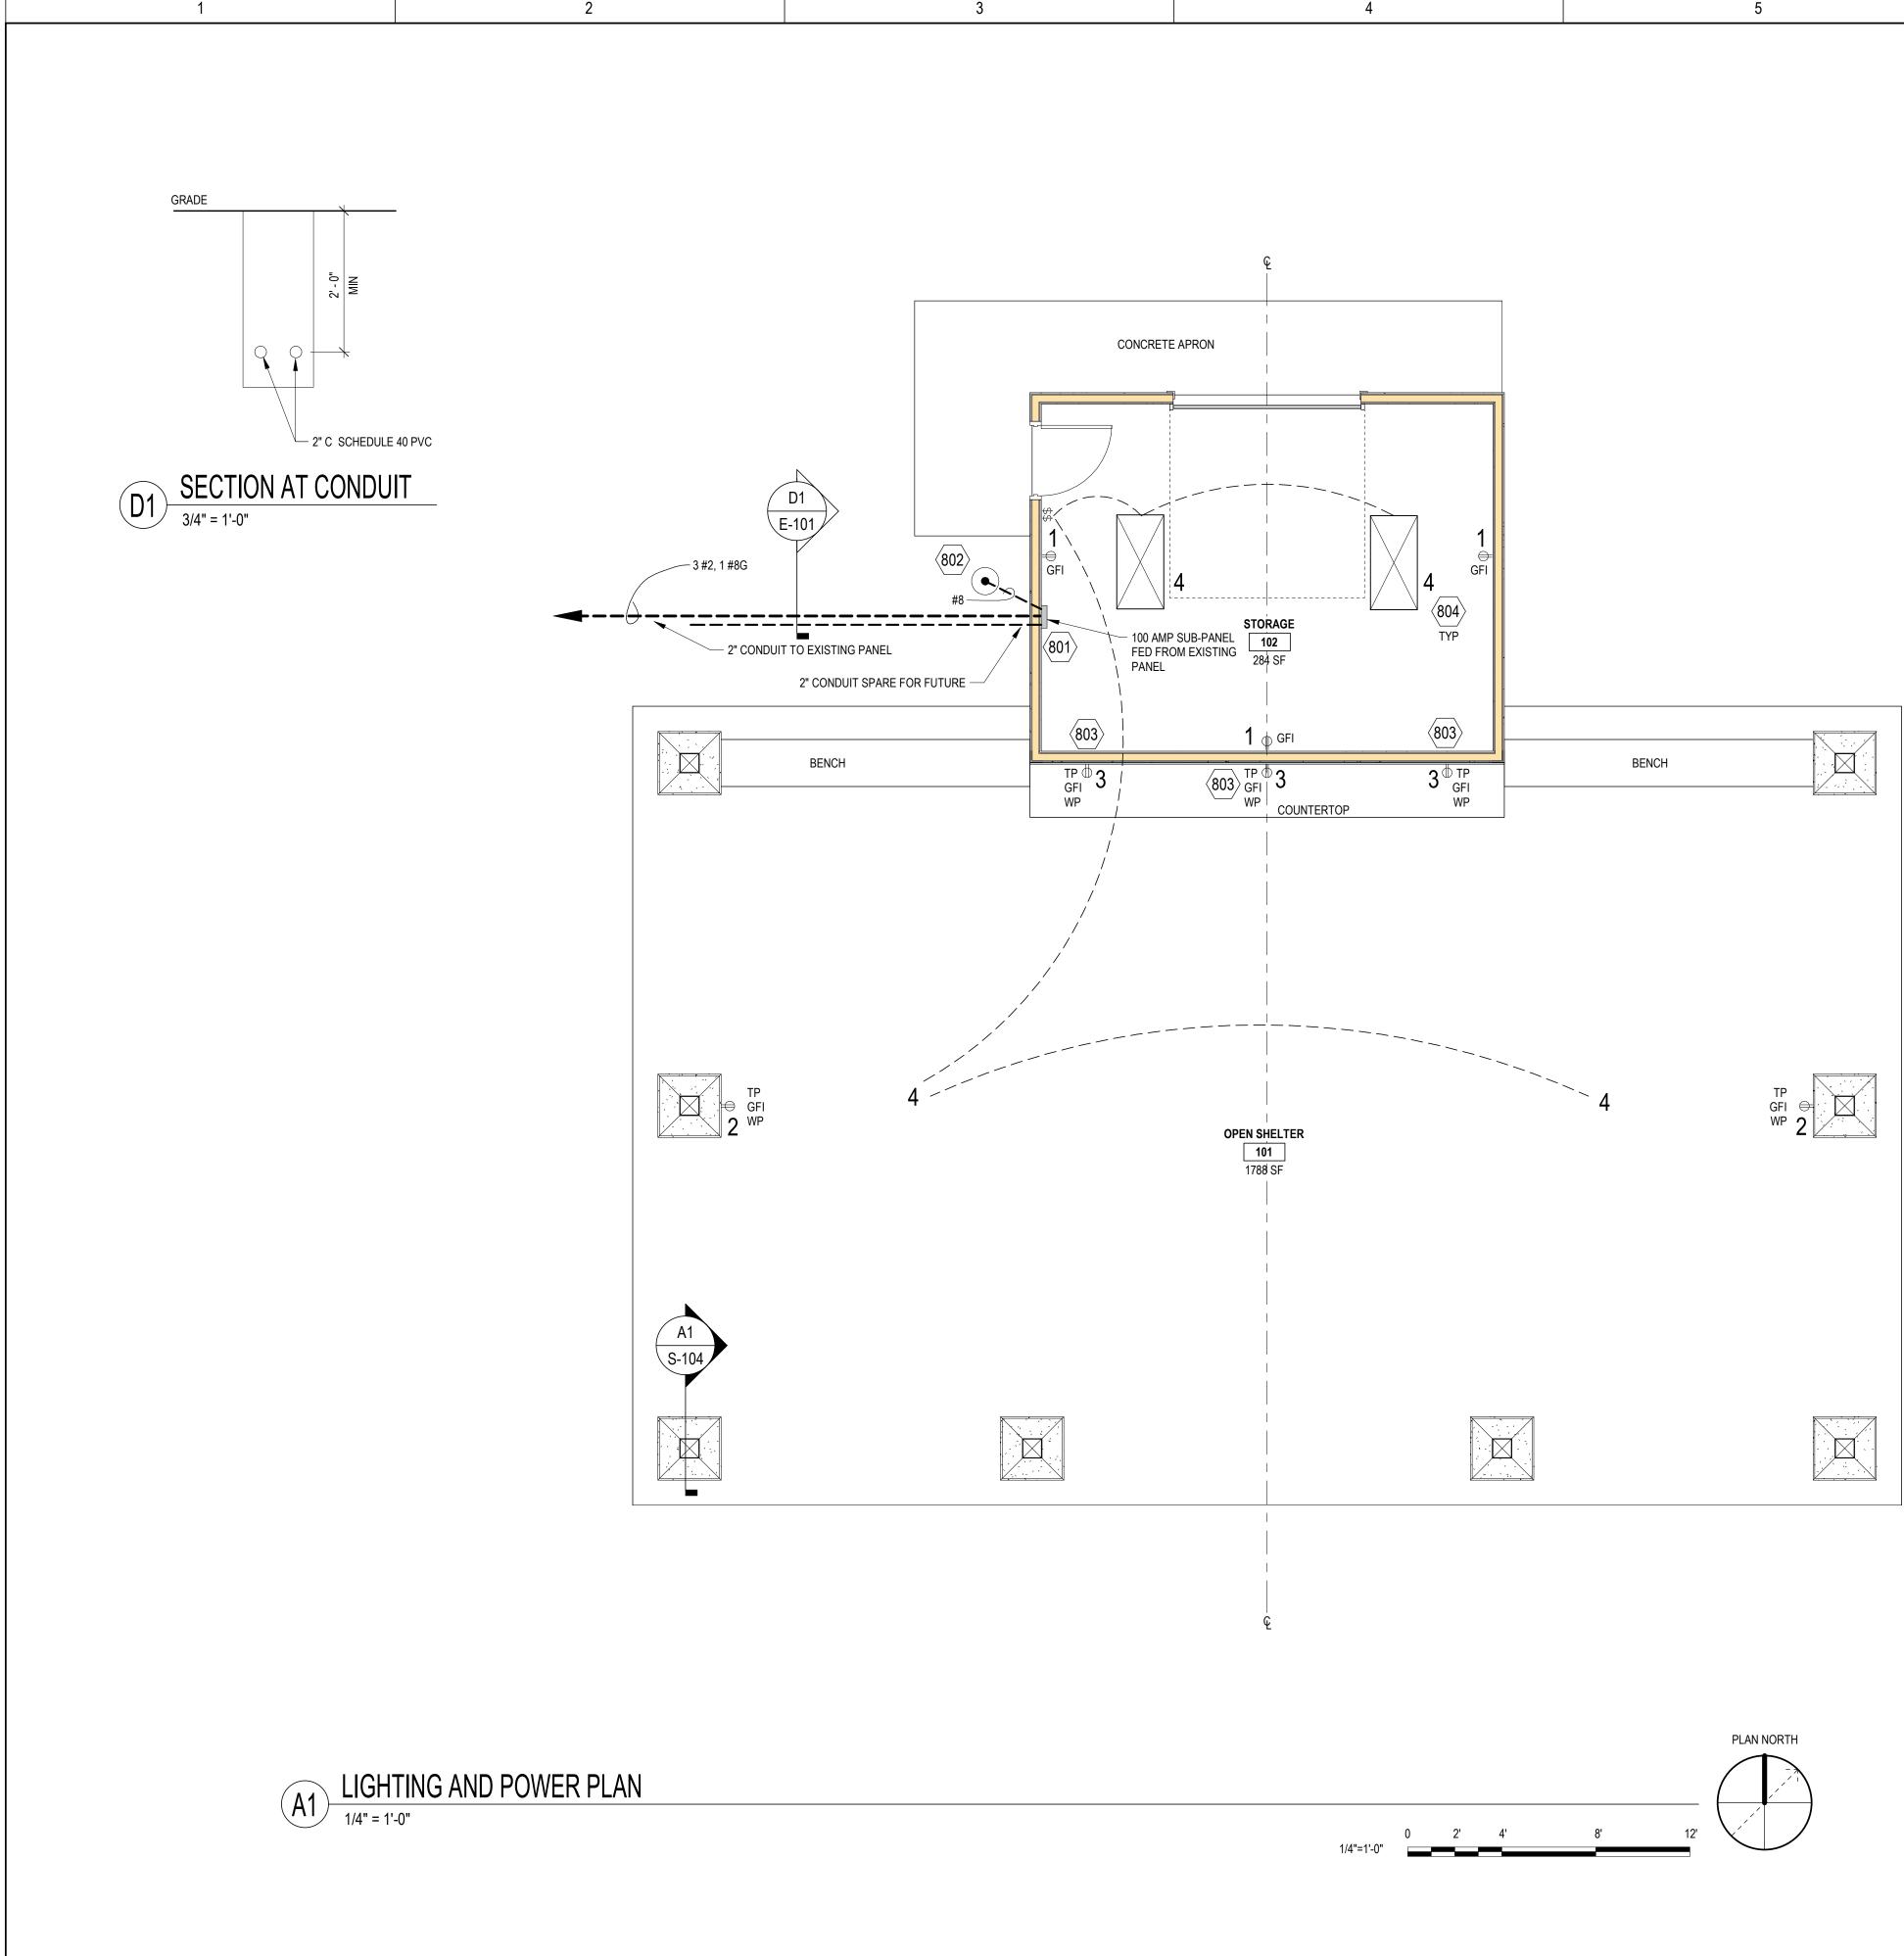

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